

NORTH POINT

KEY PLAN
<p>STRUCTURAL</p> <p>-</p> <p>MECHANICAL</p> <p>-</p> <p>ELECTRICAL</p> <p>-</p> <p>CIVIL</p> <p>SPARKS & PARTNERS CONSULTING ENGINEERS</p>




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DEVELOPMENT APPLICATION ISSUE

STAGE 1



LEGEND

- LIMIT OF WORKS
- COMPLETED WORKS
- DEMOLITION WORKS
- ACID SULPHATE SOILS NEUTRALIZATION ZONE

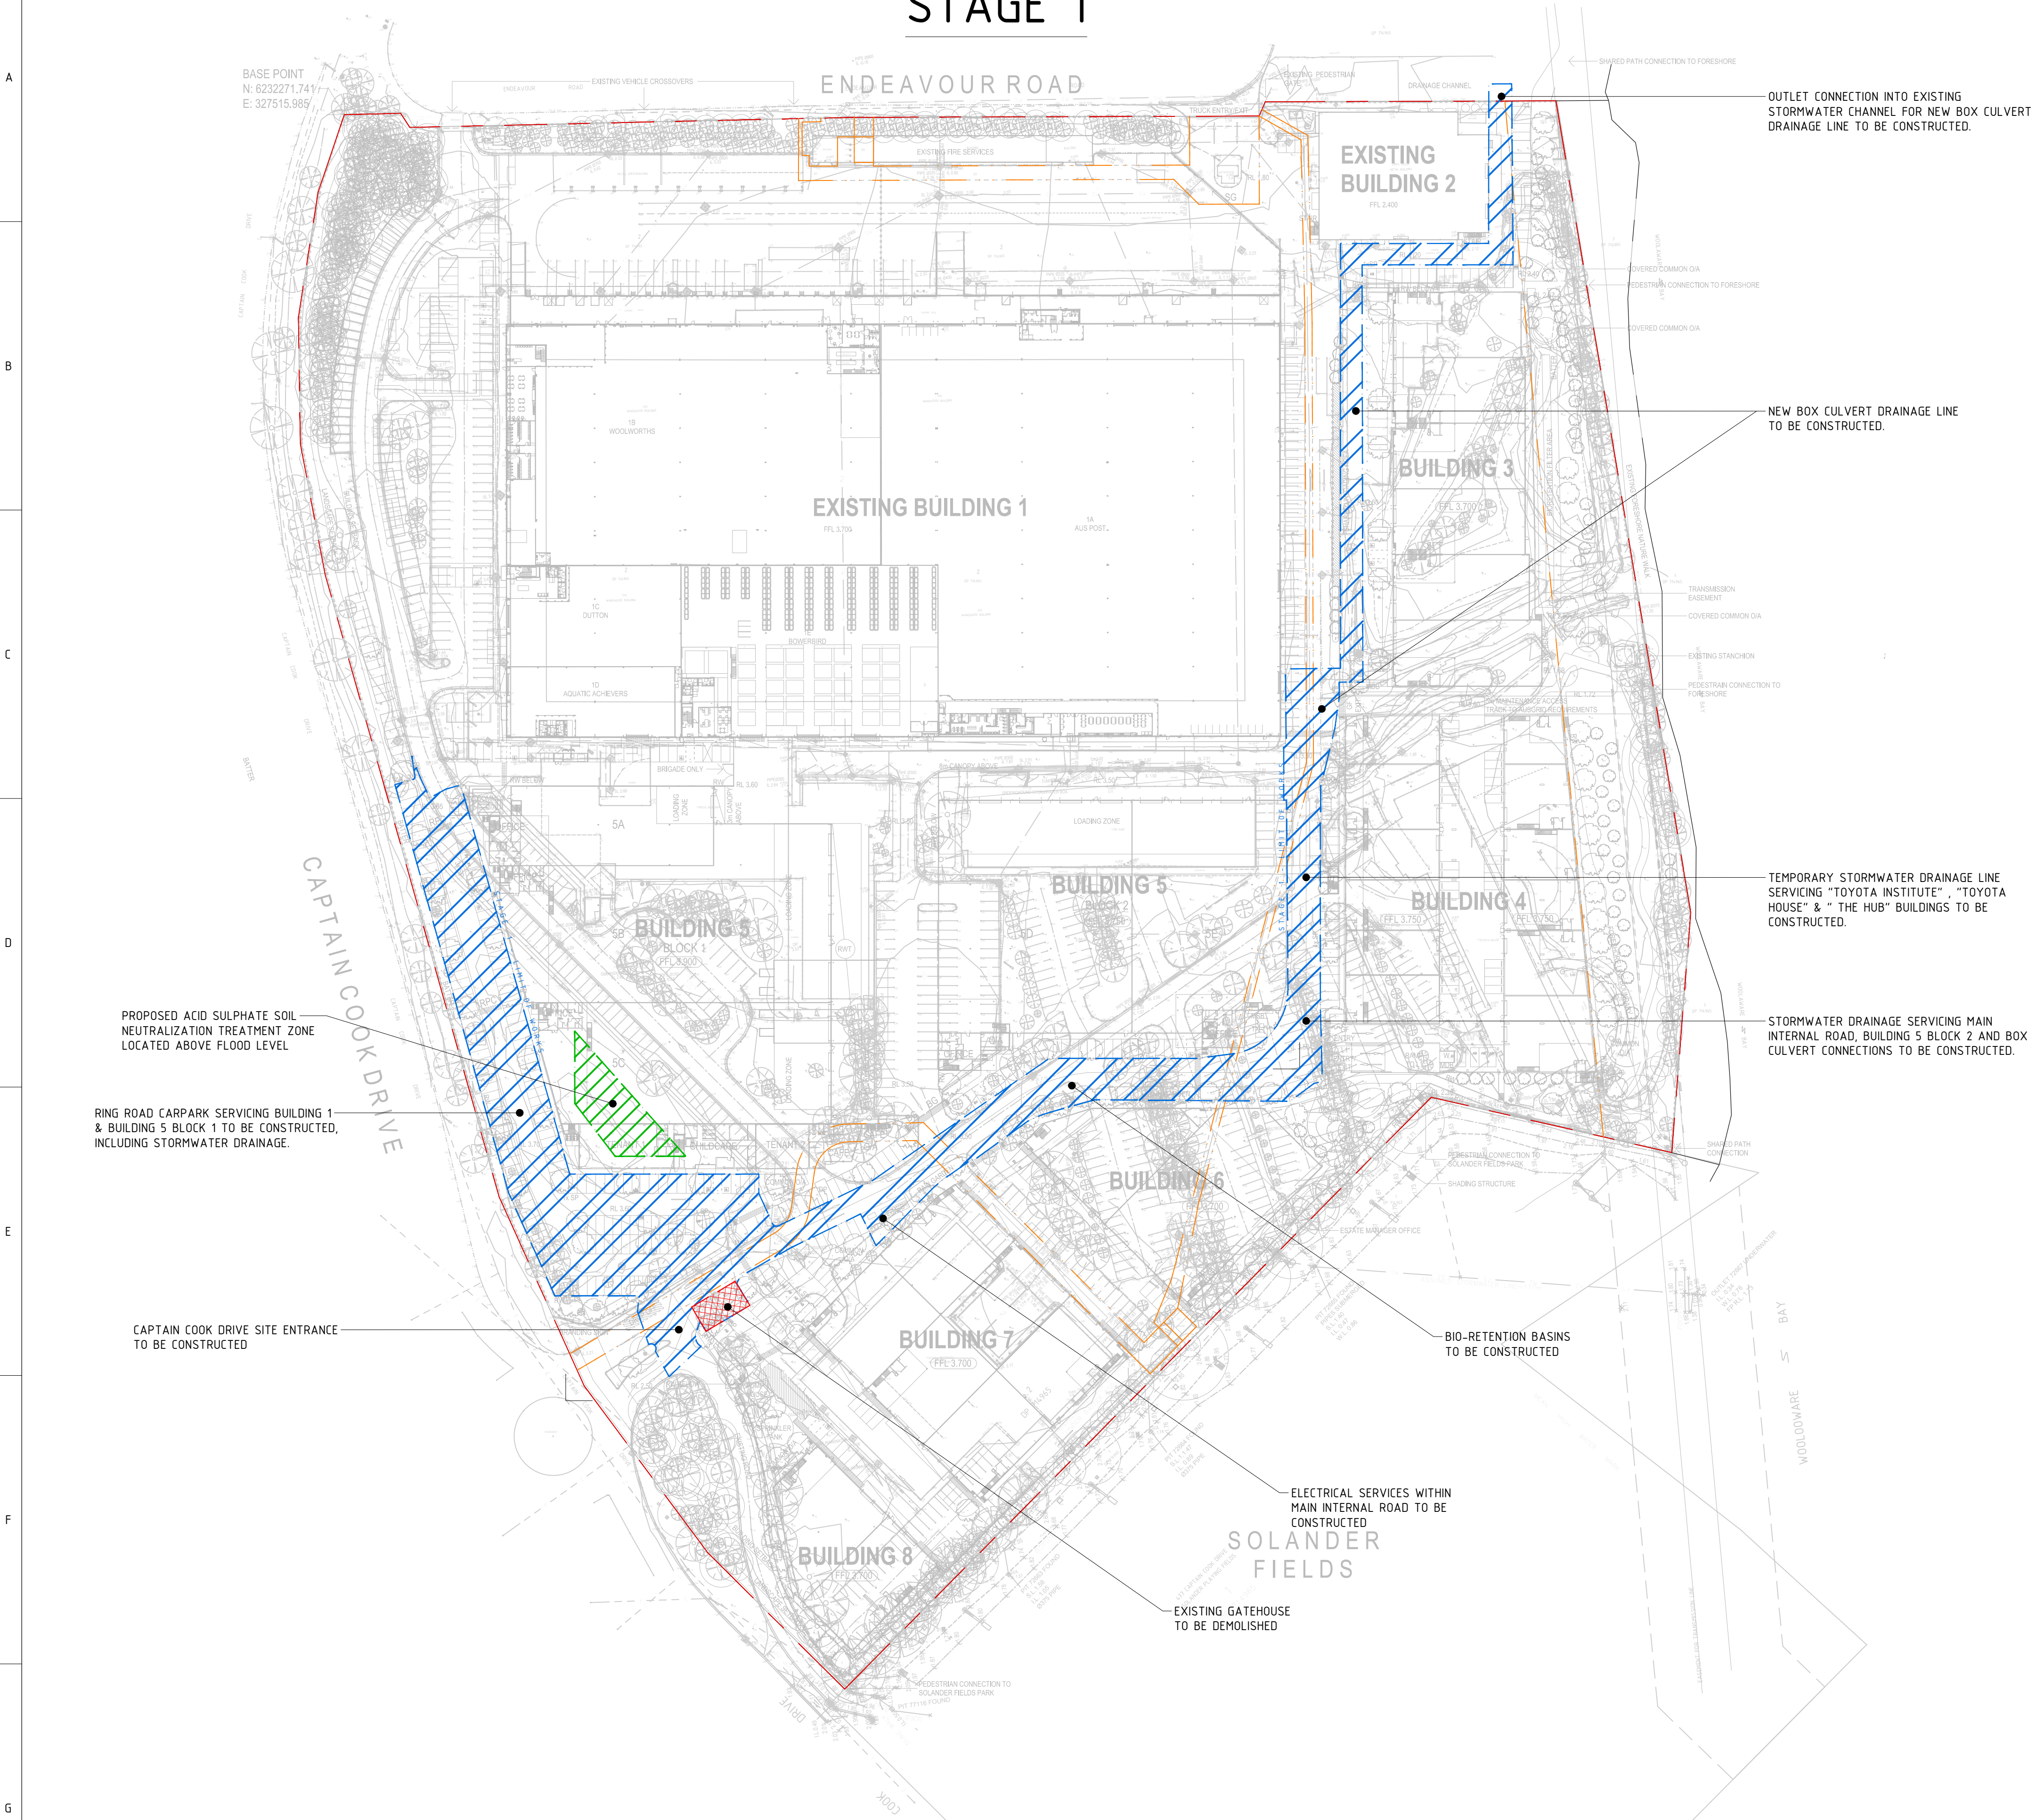NOTES

- REFER TO DA2101 - DA2103 FOR SEDIMENT & EROSION CONTROL PLANS
- REFER TO DA4101 - DA2103 FOR STORMWATER & GRADING PLAN
- ALL WORKS ARE TO ALLOW FOR TREE PROTECTION MEASURES AS PER THE ARBORICULTURAL IMPACT ASSESSMENT PREPARED BY GREEN TREE CONSULTANCY, REF AIA-P107-V2.0 SECTION 9.
- ACID SULPHATE SOILS MANAGEMENT PLAN (ASSMP) PROCEDURES ARE TO BE IMPLEMENTED AS PER THE RECOMMENDATIONS BY JBS&G AUSTRALIA PTY LTD RE: ACID SULPHATE MANAGEMENT PLAN, REF: 58037-130619, 22 JULY 2020.

IMPORTANT

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REFERENCES

DATE	AMENDMENT	INIT	REV
22.08.23	90% ISSUE	MW	1
15.09.23	DA ISSUE	MY	A
11.10.24	RESPONSE TO COUNCIL COMMENTS	MY	B
10.02.25	RESPONSE TO COUNCIL COMMENTS	MY	C

KEY PLAN

STRUCTURAL -

MECHANICAL -

ELECTRICAL -

CIVIL SPARKS & PARTNERS CONSULTING ENGINEERS

BUILDER

CLIENT

ARCHITECT

PROJECT 13 ENDEAVOUR ROAD, CARINGBAH

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DRAWING TITLE
MASTER PLAN
CONSTRUCTION MANAGEMENT
PLAN SHEET 1


DATE	DRAWN	DESIGNED	CHECKED	REVISION
JUNE 23	JK	JK	MW	

PROJECT No	SCALE	SIZE	REVISION
23106	1:100	A1	

DRAWING No	REVISION
DA1501	C

DEVELOPMENT APPLICATION ISSUE


1. REFER TO DA1501 FOR LEGENDS & GENERAL NOTES

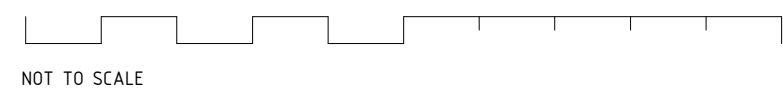[illegible]

STAGE 3

NOTES

1. REFER TO DA1501 FOR LEGENDS & GENERAL NOTES

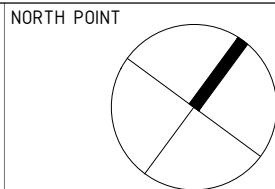

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KEY PLAN

STRUCTURAL	-
MECHANICAL	-
ELECTRICAL	-
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PROJECT
13 ENDEAVOUR ROAD, CARINGBAH

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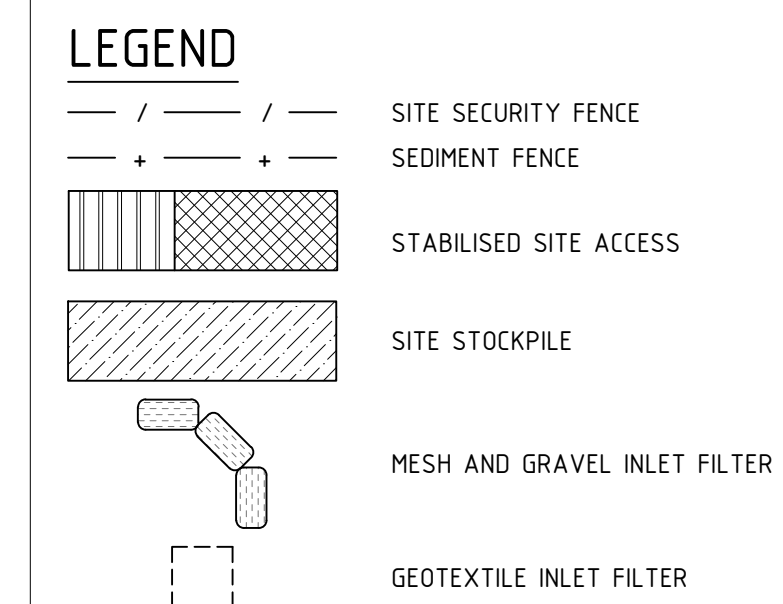
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DRAWING TITLE
MASTER PLAN
CONSTRUCTION MANAGEMENT
PLAN SHEET 3

DATE	DRAWN	DESIGNED	CHECKED	REVISION
JUNE 23	JK	JK	MW	
PROJECT No	SCALE	SIZE	REVISION	
23106	1:100	A1		
DRAWING No	DA1503			

DEVELOPMENT APPLICATION ISSUE

STAGE 1 – ESCP



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KEY PLAN

STRUCTURAL

MECHANICAL

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ARCHITECT



PROJECT	
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13 ENDEAVOUR ROAD, CARINGBAH



DRAWING TITLE

MASTER PLAN
CONCEPT SEDIMENT & EROSION
CONTROL PLAN SHEET 1

DATE	DRAWN	DESIGNED	CHECKED
JUNE 23	JK	JK	MW
PROJECT No	SCALE	SIZE	REVISION
23106	1:100	A1	
	DRAWING No		
	DA2101		


DEVELOPMENT APPLICATION ISSUE

STAGE 2 - ESCP

NOTES

1. REFER TO DA2101 FOR LEGENDS & GENERAL NOTES

NORTH POINT

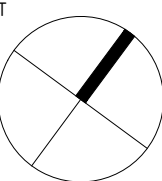

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KEY PLAN

STRUCTURAL

MECHANICAL

ELECTRICAL

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ARCHITECT

watson
young

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DRAWING TITLE

MASTER PLAN
CONCEPT SEDIMENT & EROSION
CONTROL PLAN SHEET 2

DATE	DRAWN	DESIGNED	CHECKED	REVISION
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PROJECT No	SCALE	SIZE	REVISION	
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DRAWING No	DA2102			


DEVELOPMENT APPLICATION ISSUE

STAGE 3 - ESCP

NOTES

1. REFER TO DA2101 FOR LEGENDS & GENERAL NOTES

NORTH POINT

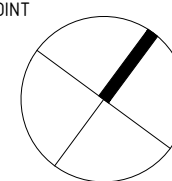

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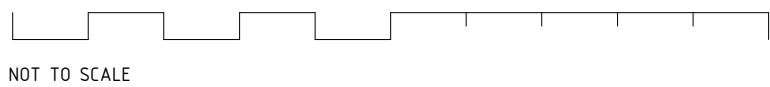


DRAWING TITLE

MASTER PLAN
CONCEPT SEDIMENT & EROSION
CONTROL PLAN SHEET 3

DATE	DRAWN	DESIGNED	CHECKED	REVISION
JUNE 23	JK	JK	MW	
PROJECT No	SCALE	SIZE	REVISION	
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DRAWING No	DA2103			

DEVELOPMENT APPLICATION ISSUE




BULK EARTHWORKS NOTES

1. BULK EARTHWORKS ARE TO BE UNDERTAKEN IN ACCORDANCE WITH AS3798-2007, GUIDELINES ON EARTHWORKS FOR COMMERCIAL AND RESIDENTIAL DEVELOPMENTS.
2. THE CONTRACTOR SHALL REFER TO THE GEOTECHNICAL INVESTIGATION REPORT FOR SPECIFIC SITE CONDITIONS AND WORKS METHODOLOGY.
3. CUT TO FILL DEPTHS SHOWN ARE BASED ON LEVELS AND PAVEMENT THICKNESS' IN COMPARISON TO SURVEY REFERENCED IN C1201 RESULTING IN THE FOLLOWING CUT TO FILL VOLUMES:

$$\begin{aligned}\text{CUT} &= 6,420\text{m}^3 \\ \text{FILL} &= 46,443\text{m}^3 \\ \text{TOTAL CUT / FILL} &= 40,022\text{m}^3\end{aligned}$$
4. STRIPPING OF THE FOLLOWING SURFACES HAS BEEN TAKEN INTO ACCOUNT IN THE ABOVE VOLUME CALCULATIONS:
 - EXISTING EXTERNAL HARDSTAND = 200mm
 - EXISTING WAREHOUSE/OFFICE SLABS = 200mm
 - EXISTING VEGETATION = 200mm
5. VOLUMES DETAILED ABOVE DO NOT TAKE INTO ACCOUNT BULKING & COMPACTION OF THE MATERIAL, TEMPORARY SEDIMENT BASIN, DETAILED EXCAVATION, TRENCHING EXCAVATION, GROUND IMPROVEMENT WORKS, OR PAVEMENT PRE-LOADING
6. VOLUMES BASED ON THE FOLLOWING PAVEMENT THICKNESS' TAKEN FROM FINISHED SURFACE:
 - WAREHOUSE BUILDING PAD
270mm (170mm SLAB + 100mm SUB-BASE)
 - OFFICE BUILDING PAD
270mm (170mm SLAB + 100mm SUB-BASE)
 - HARDSTAND AREA
270mm (170mm SLAB + 100mm SUB-BASE)
 - LANDSCAPE AREAS
300mm (TOPSOIL OR OTHER LANDSCAPING)
 - ASPHALT ROAD AREA
410mm (30mm ASPHALT + 180mm BASE + 200mm SUB-BASE)
6. THE CONTRACTOR SHALL VERIFY LEVELS PRIOR TO CONSTRUCTION COMMENCEMENT, ANY DISCREPANCIES SHALL BE NOTIFIED TO THE ENGINEER OR SUPERINTENDENT FOR CLARIFICATION.
7. REFER TO C3501 FOR BULK EARTHWORKS SECTIONS

DEVELOPMENT APPLICATION ISSUE

NORTH POINT



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STRUCTURAL	
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MECHANICAL	
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**watson
young**


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MASTER PLAN
CONCEPT BULK EARTHWORKS CUT
TO FILL PLAN

DATE	DRAWN	DESIGNED	CHECKED
JUNE 23	JK	JK	MW
PROJECT No	SCALE	SIZE	REVISION
23106	1:100	A1	
	DRAWING No		
	DA3101		



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REFERENCES

DATE	AMENDMENT	INIT	REV
16.06.23	20% ISSUE	JK	1
29.06.23	REVISED SITE GRADING	MY	2
10.07.23	50% ISSUE	JK	3
28.07.23	75% ISSUE	JK	4
22.08.23	90% ISSUE	MW	5
15.09.23	DA ISSUE	MY	A
11.10.24	RESPONSE TO COUNCIL COMMENTS	MY	B
10.02.25	RESPONSE TO COUNCIL COMMENTS	MY	C
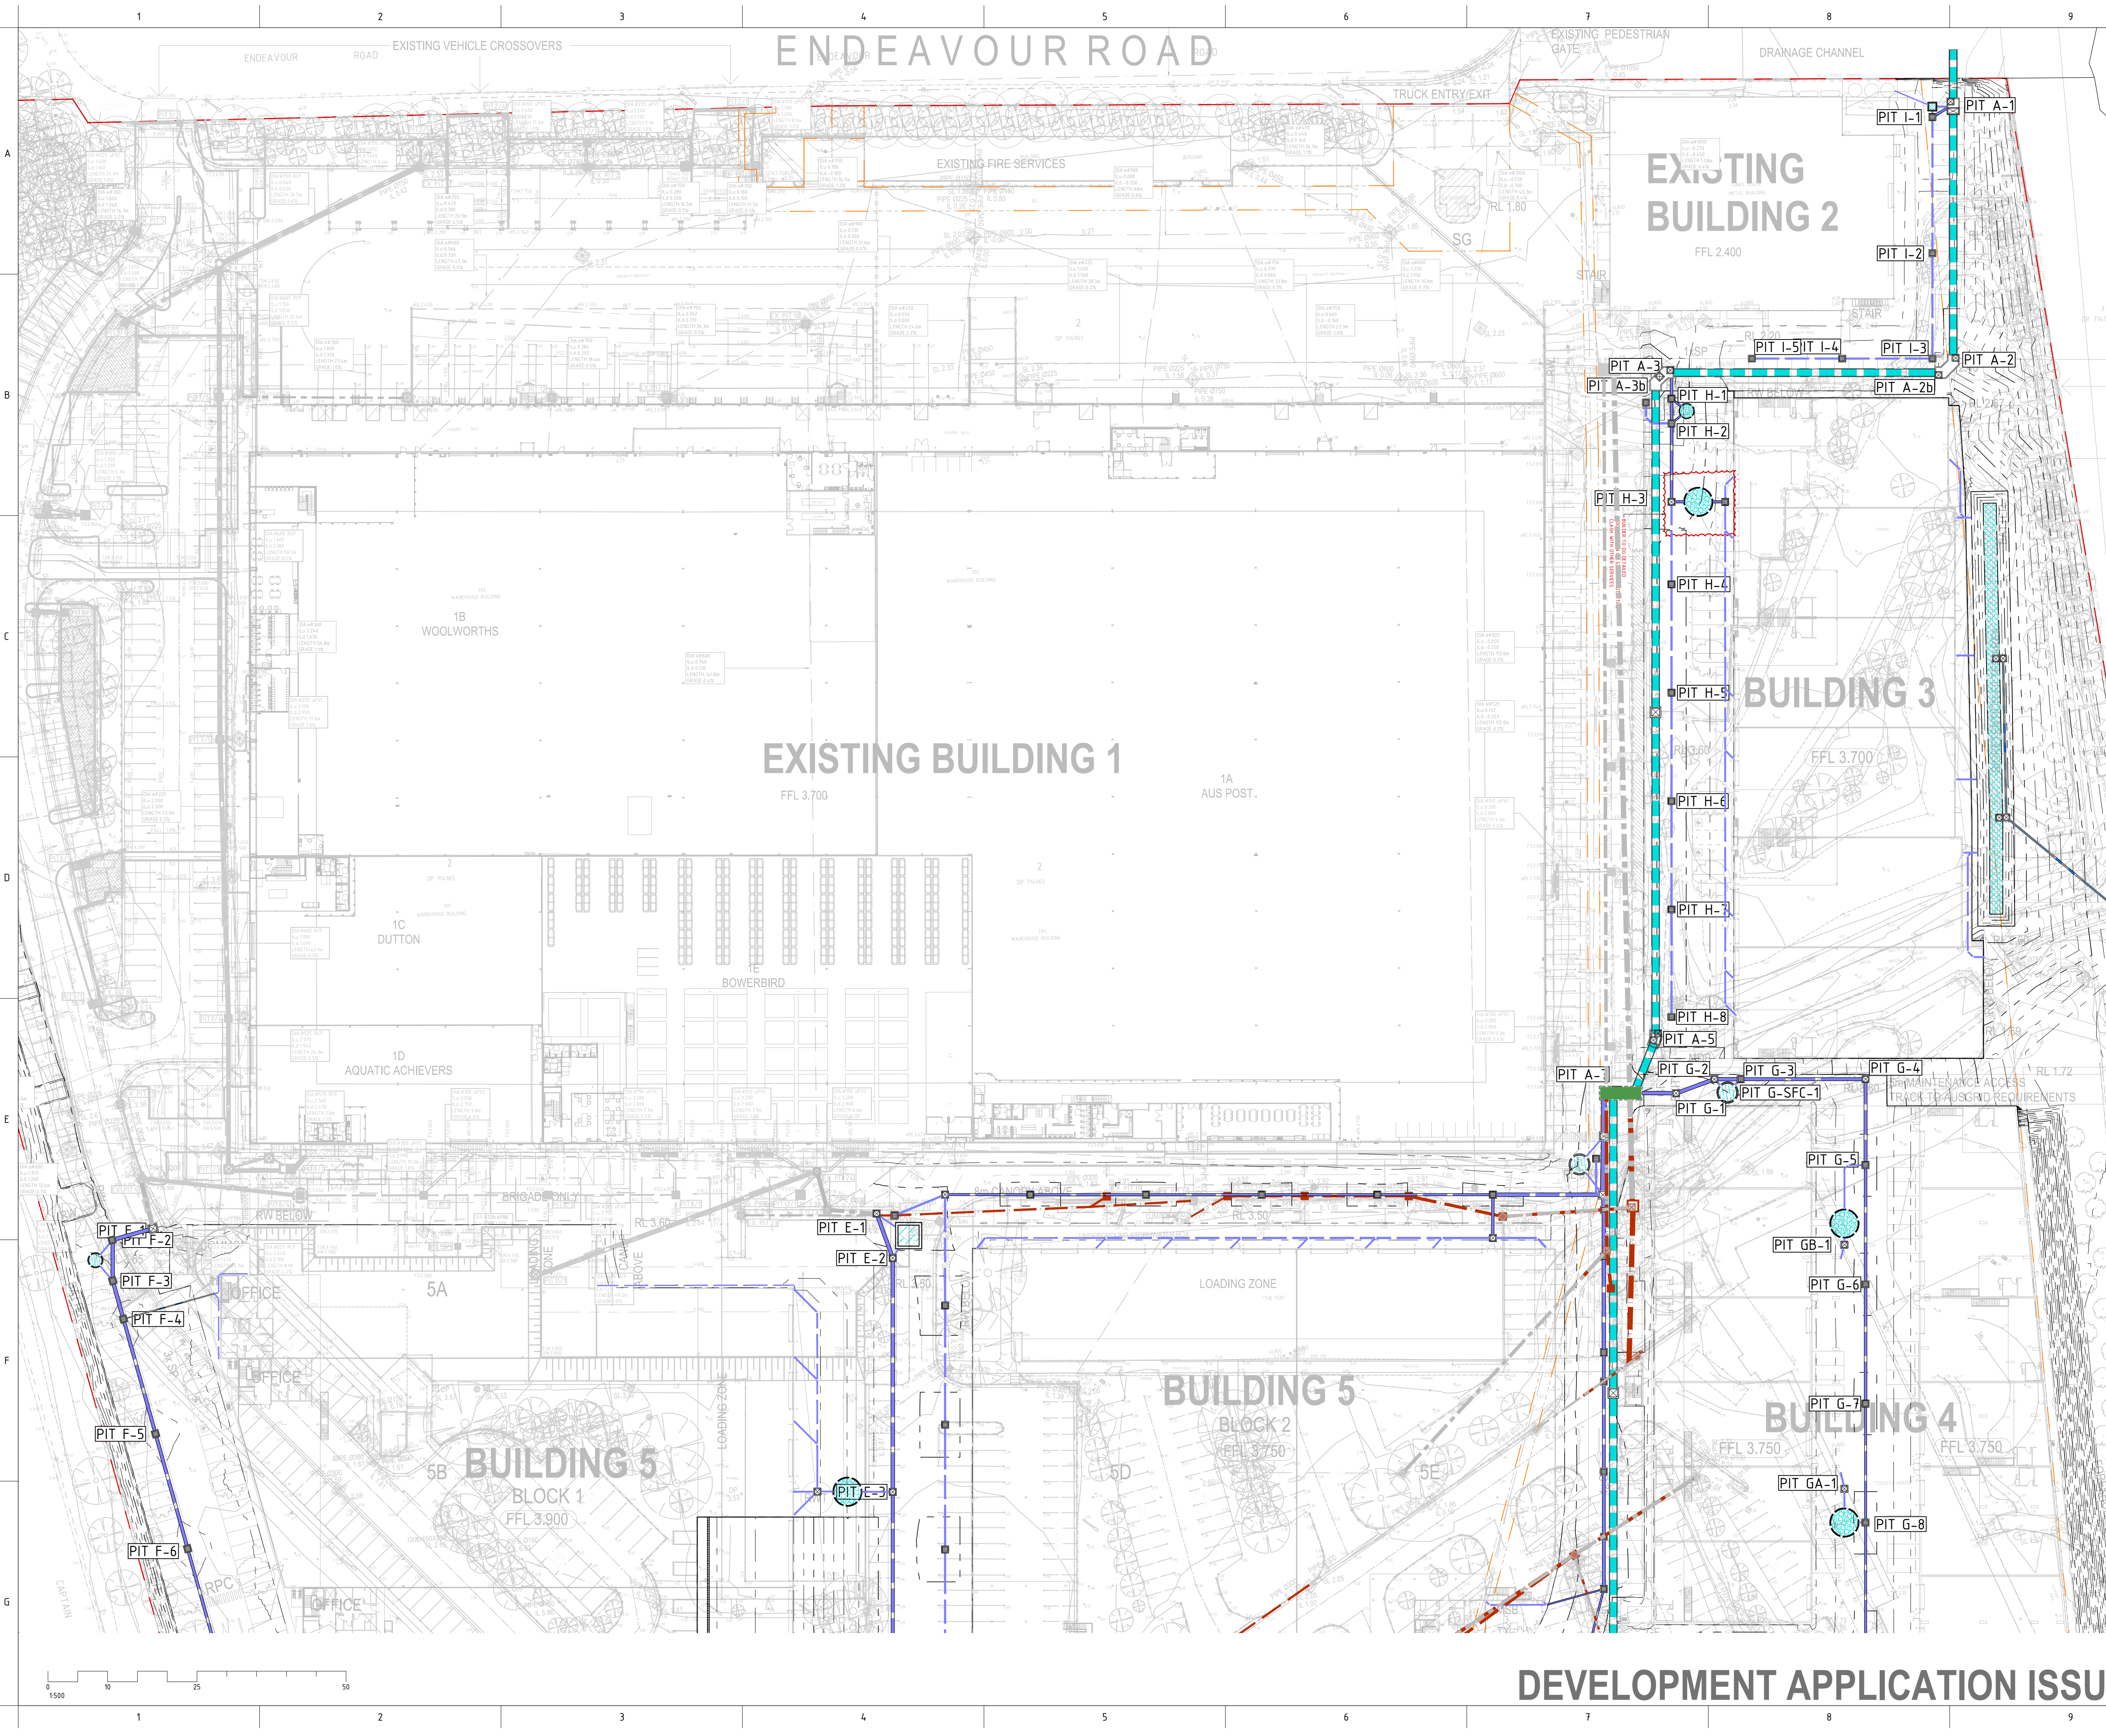
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13 ENDEAVOUR ROAD, CARINGBAH

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HCAA FPA GOLD MEMBER JAS-ANZ

DRAWING TITLE

MASTER PLAN
CONCEPT STORMWATER &
GRADING PLAN - SHEET 1

DATE	DRAWN	DESIGNED	CHECKED	MW
JUNE 23	JK	JK	JK	MW

PROJECT No

23106

SCALE

1:500

SIZE

A1


REVISION

DRAWING No

DA4101

C

DEVELOPMENT APPLICATION ISSUE

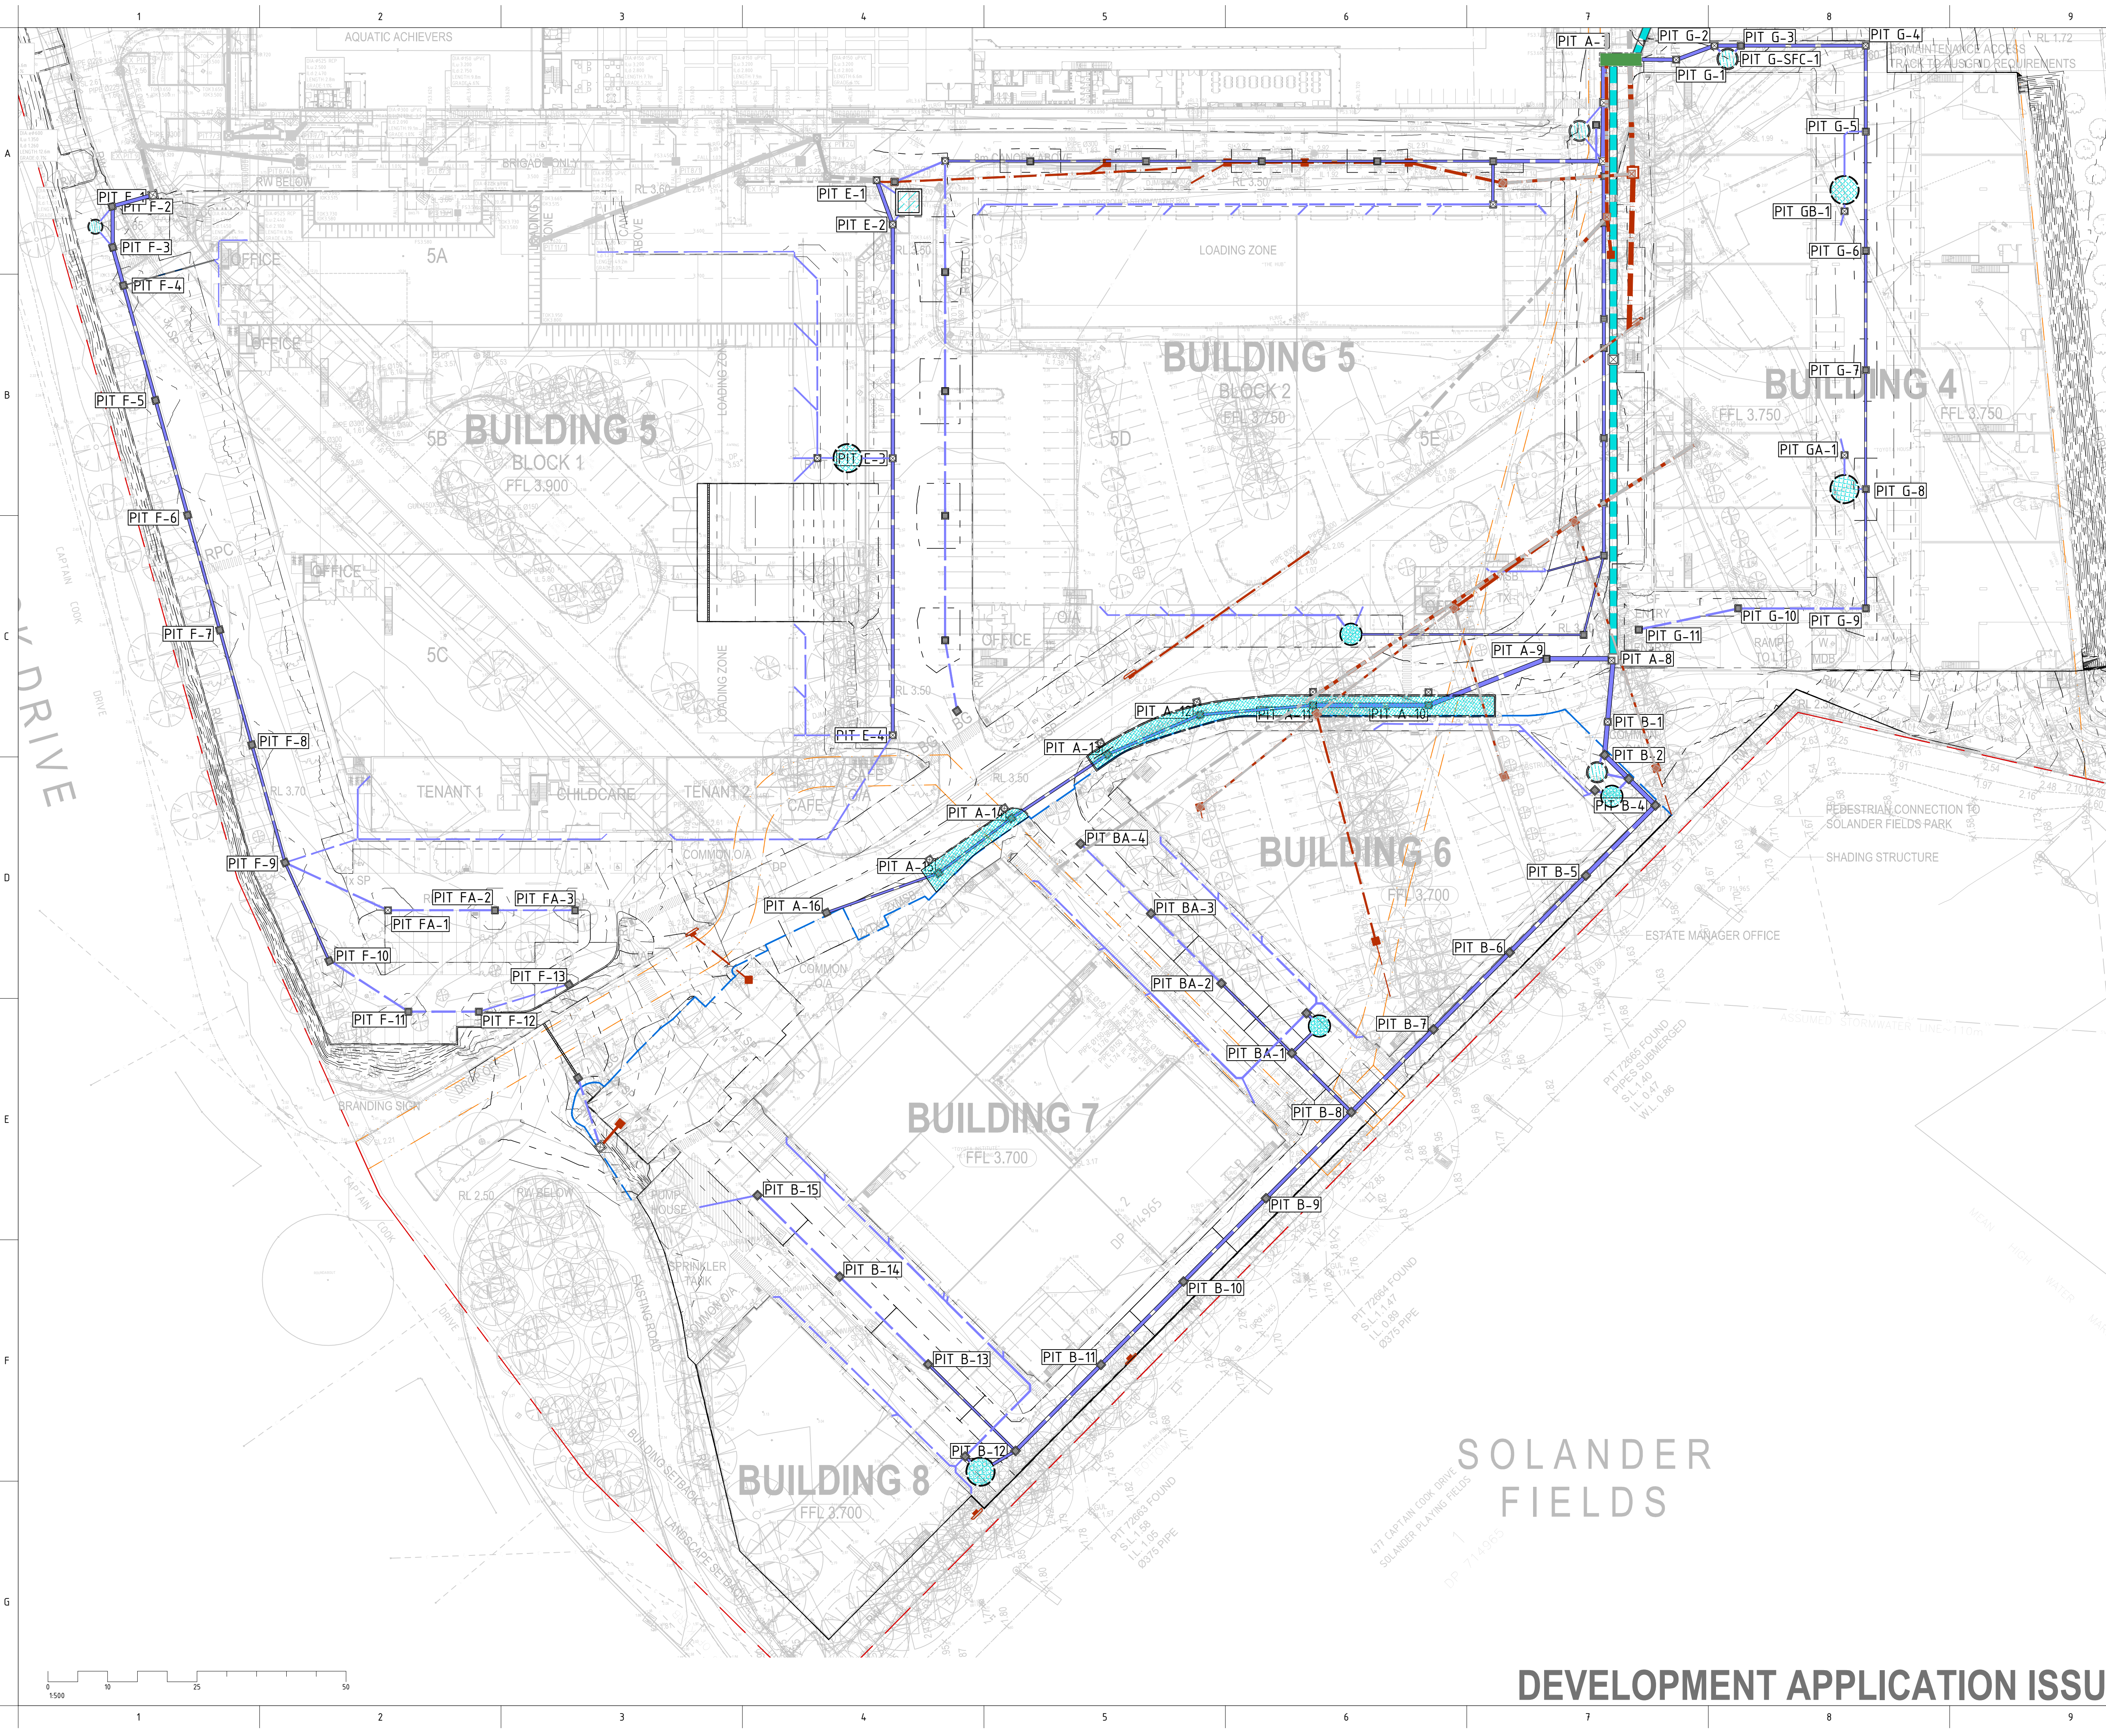

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REFERENCES

DATE	AMENDMENT	INIT	REV
11.10.24	RESPONSE TO COUNCIL COMMENTS	MY	1
10.02.25	RESPONSE TO COUNCIL COMMENTS	MY	A

KEY PLAN

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13 ENDEAVOUR ROAD, CARINGBAH

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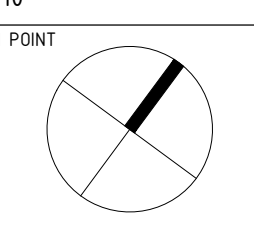
MASTER PLAN
CONCEPT STORMWATER &
GRADING PLAN - SHEET 2


DATE	DRAWN	DESIGNED	CHECKED	MW
JUNE 23	JK	JK		

PROJECT No	SCALE	SIZE	REVISION
23106	1:500	A1	

DRAWING No	DA4102	A

DEVELOPMENT APPLICATION ISSUE



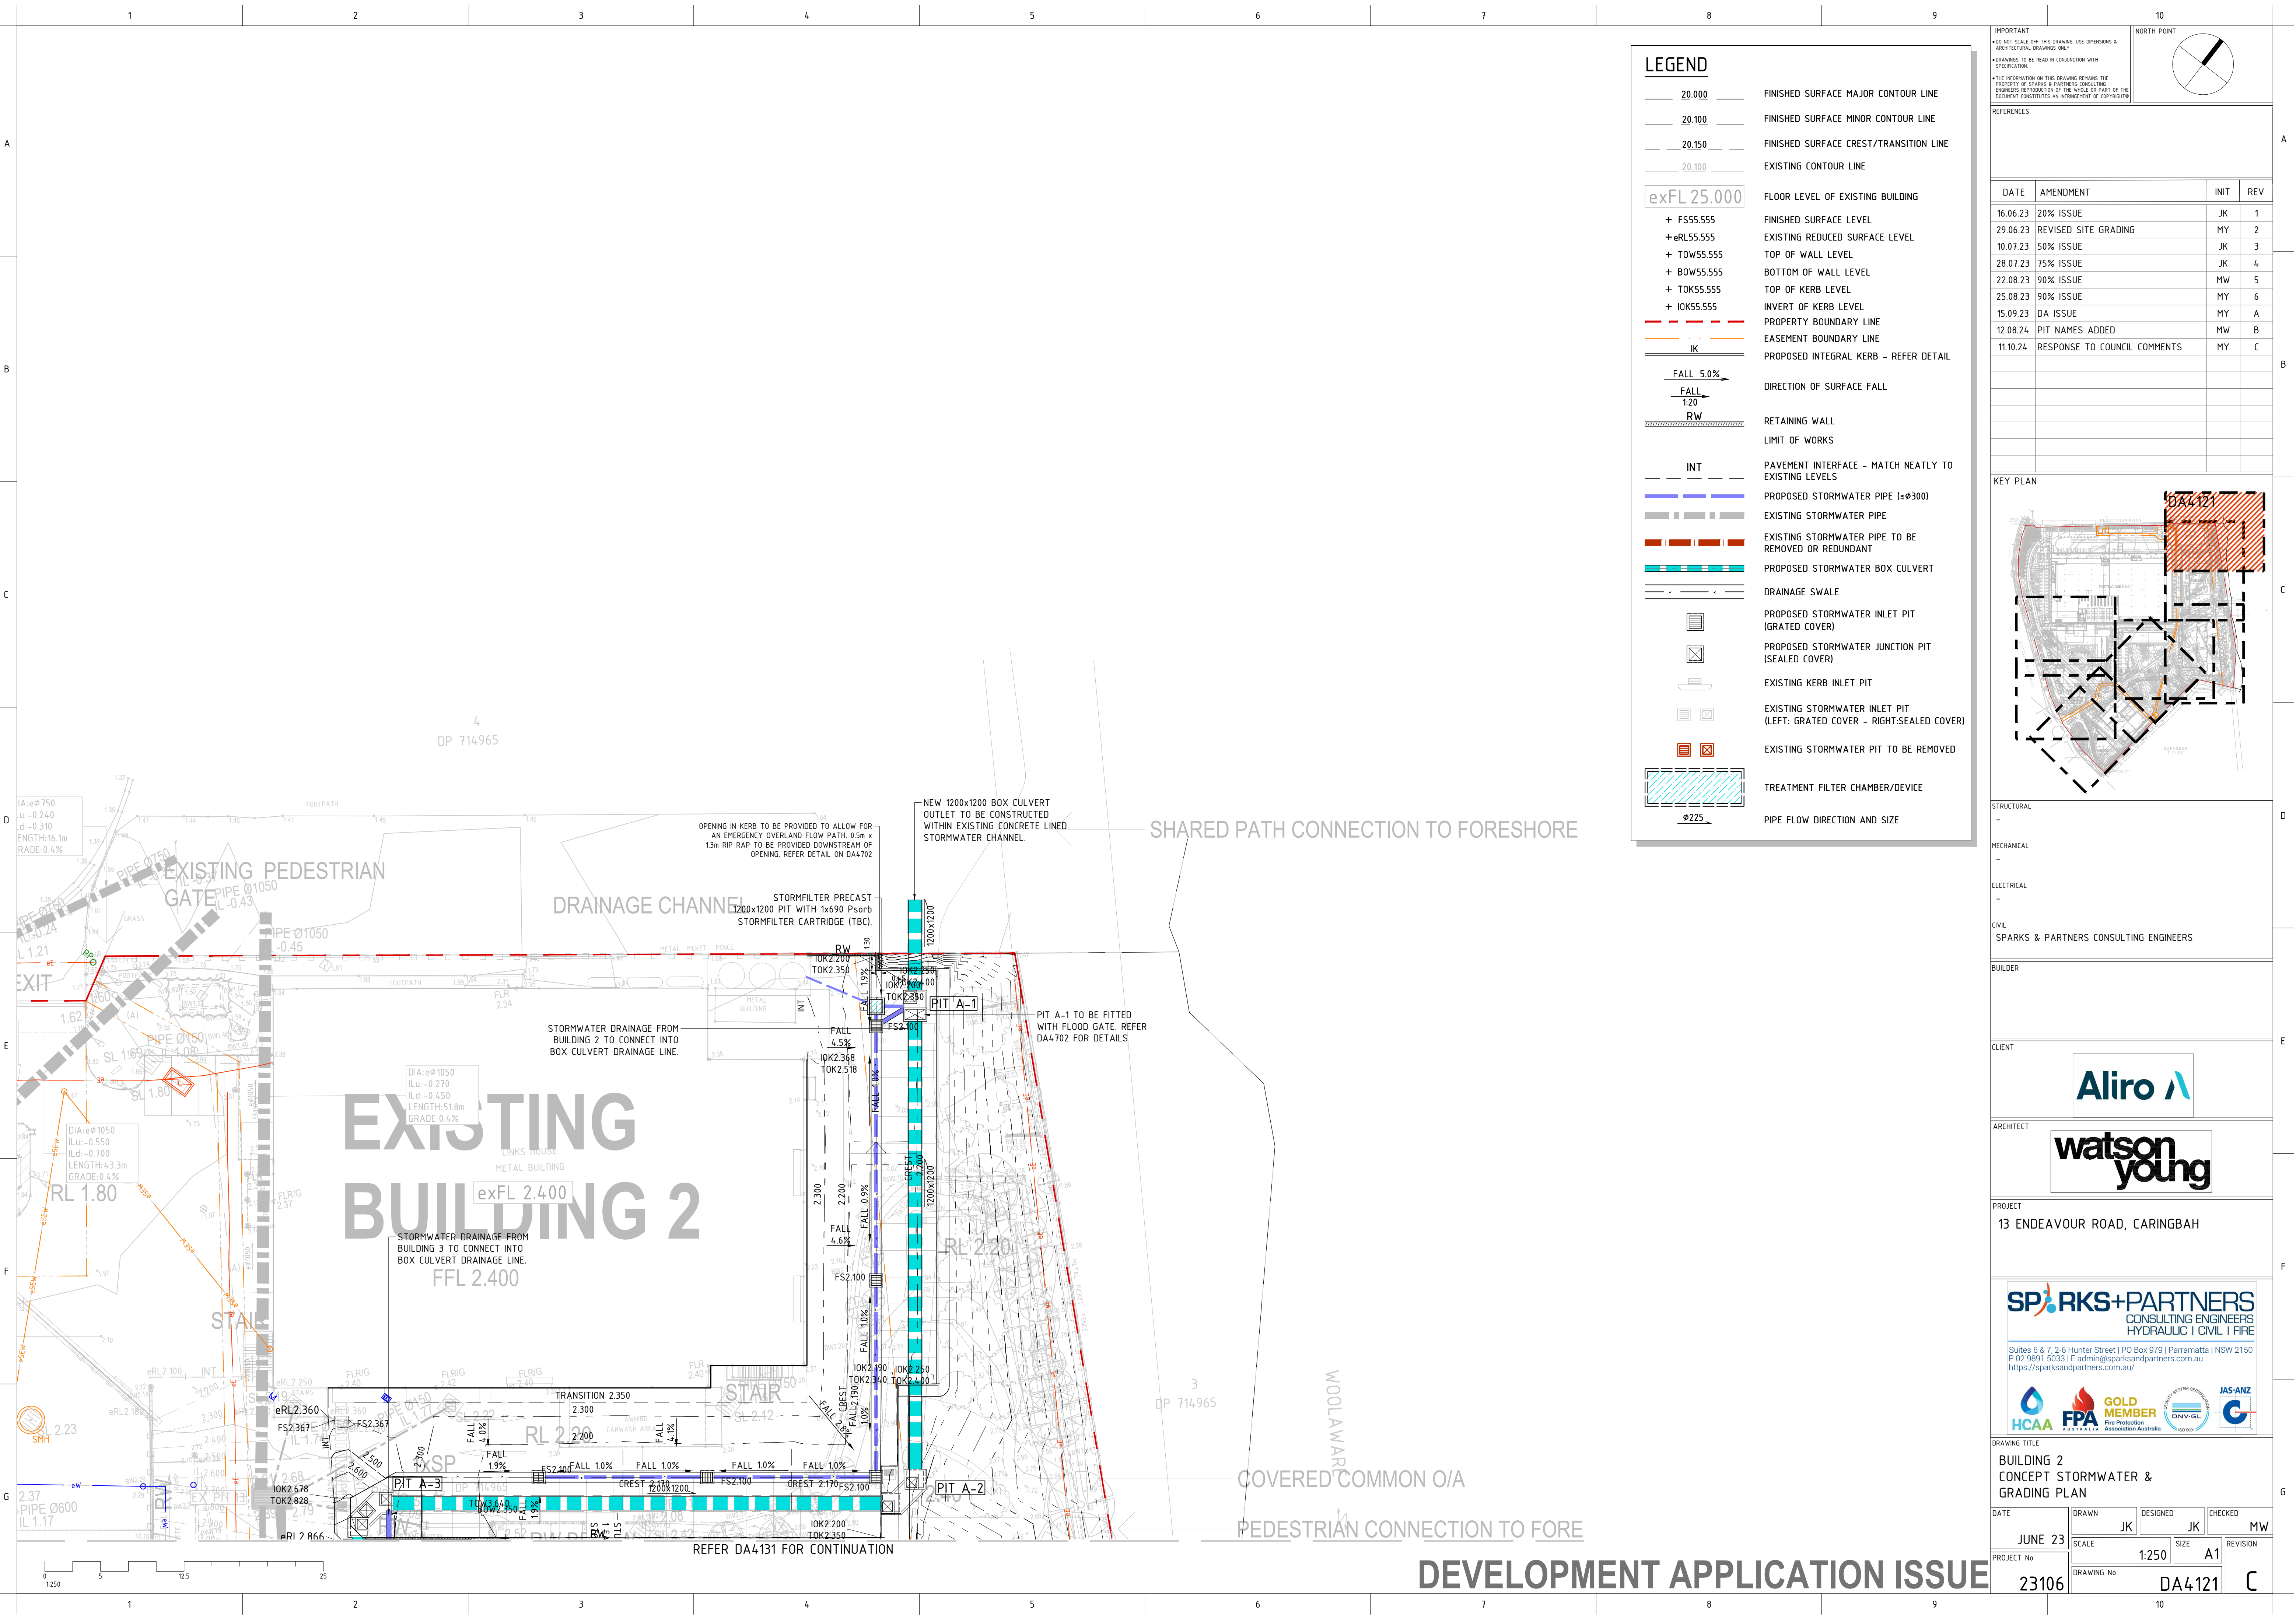

LEGEND

20.000

20.100

20.150

20.100

exFL 25.000

+ FS55.555

+ eRL55.555

+ TOW55.555

+ BOW55.555

+ TOK55.555

+ IOK55.555

IK

FALL 5.0%

FALL 1:20

RW

INT

PROPOSED STORMWATER PIPE (ø300)

EXISTING STORMWATER PIPE

EXISTING STORMWATER PIPE TO BE REMOVED OR REDUNDANT

PROPOSED STORMWATER BOX CULVERT

DRAINAGE SWALE

PROPOSED STORMWATER INLET PIT (GRADED COVER)

PROPOSED STORMWATER JUNCTION PIT (SEALED COVER)

EXISTING KERB INLET PIT

EXISTING STORMWATER INLET PIT (LEFT: GRADED COVER - RIGHT:SEALED COVER)

EXISTING STORMWATER PIT TO BE REMOVED

TREATMENT FILTER CHAMBER/DEVICE

ø225

FINISHED SURFACE MAJOR CONTOUR LINE

FINISHED SURFACE MINOR CONTOUR LINE

FINISHED SURFACE CREST/TRANSITION LINE

EXISTING CONTOUR LINE

FLOOR LEVEL OF EXISTING BUILDING

FINISHED SURFACE LEVEL

EXISTING REDUCED SURFACE LEVEL

TOP OF WALL LEVEL

BOTTOM OF WALL LEVEL

TOP OF KERB LEVEL

INVERT OF KERB LEVEL

PROPERTY BOUNDARY LINE

EASEMENT BOUNDARY LINE

PROPOSED INTEGRAL KERB - REFER DETAIL

DIRECTION OF SURFACE FALL

RETAINING WALL

LIMIT OF WORKS

PAVEMENT INTERFACE - MATCH NEATLY TO EXISTING LEVELS

EXISTING STORMWATER PIPE

EXISTING STORMWATER PIPE TO BE REMOVED OR REDUNDANT

PROPOSED STORMWATER BOX CULVERT

DRAINAGE SWALE

PROPOSED STORMWATER INLET PIT (GRADED COVER)

PROPOSED STORMWATER JUNCTION PIT (SEALED COVER)

EXISTING KERB INLET PIT

EXISTING STORMWATER INLET PIT (LEFT: GRADED COVER - RIGHT:SEALED COVER)

EXISTING STORMWATER PIT TO BE REMOVED

TREATMENT FILTER CHAMBER/DEVICE

PIPE FLOW DIRECTION AND SIZE

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22.08.23	90% ISSUE	MW	5
25.08.23	90% ISSUE	MY	6
15.09.23	DA ISSUE	MY	A
12.08.24	PIT NAMES ADDED	MW	B
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KEY PLAN

STRUCTURAL

-

MECHANICAL

-

ELECTRICAL

-

CIVIL

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13 ENDEAVOUR ROAD, CARINGBAH

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DRAWING TITLE

BUILDING 2
CONCEPT STORMWATER & GRADING PLAN

DATE

JUNE 23

SCALE

23106

DRAWN

JK

DESIGNED

JK

CHECKED

MW

PROJECT No

23106

SIZE

1:250


REVISION

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
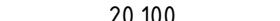
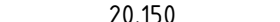







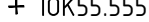


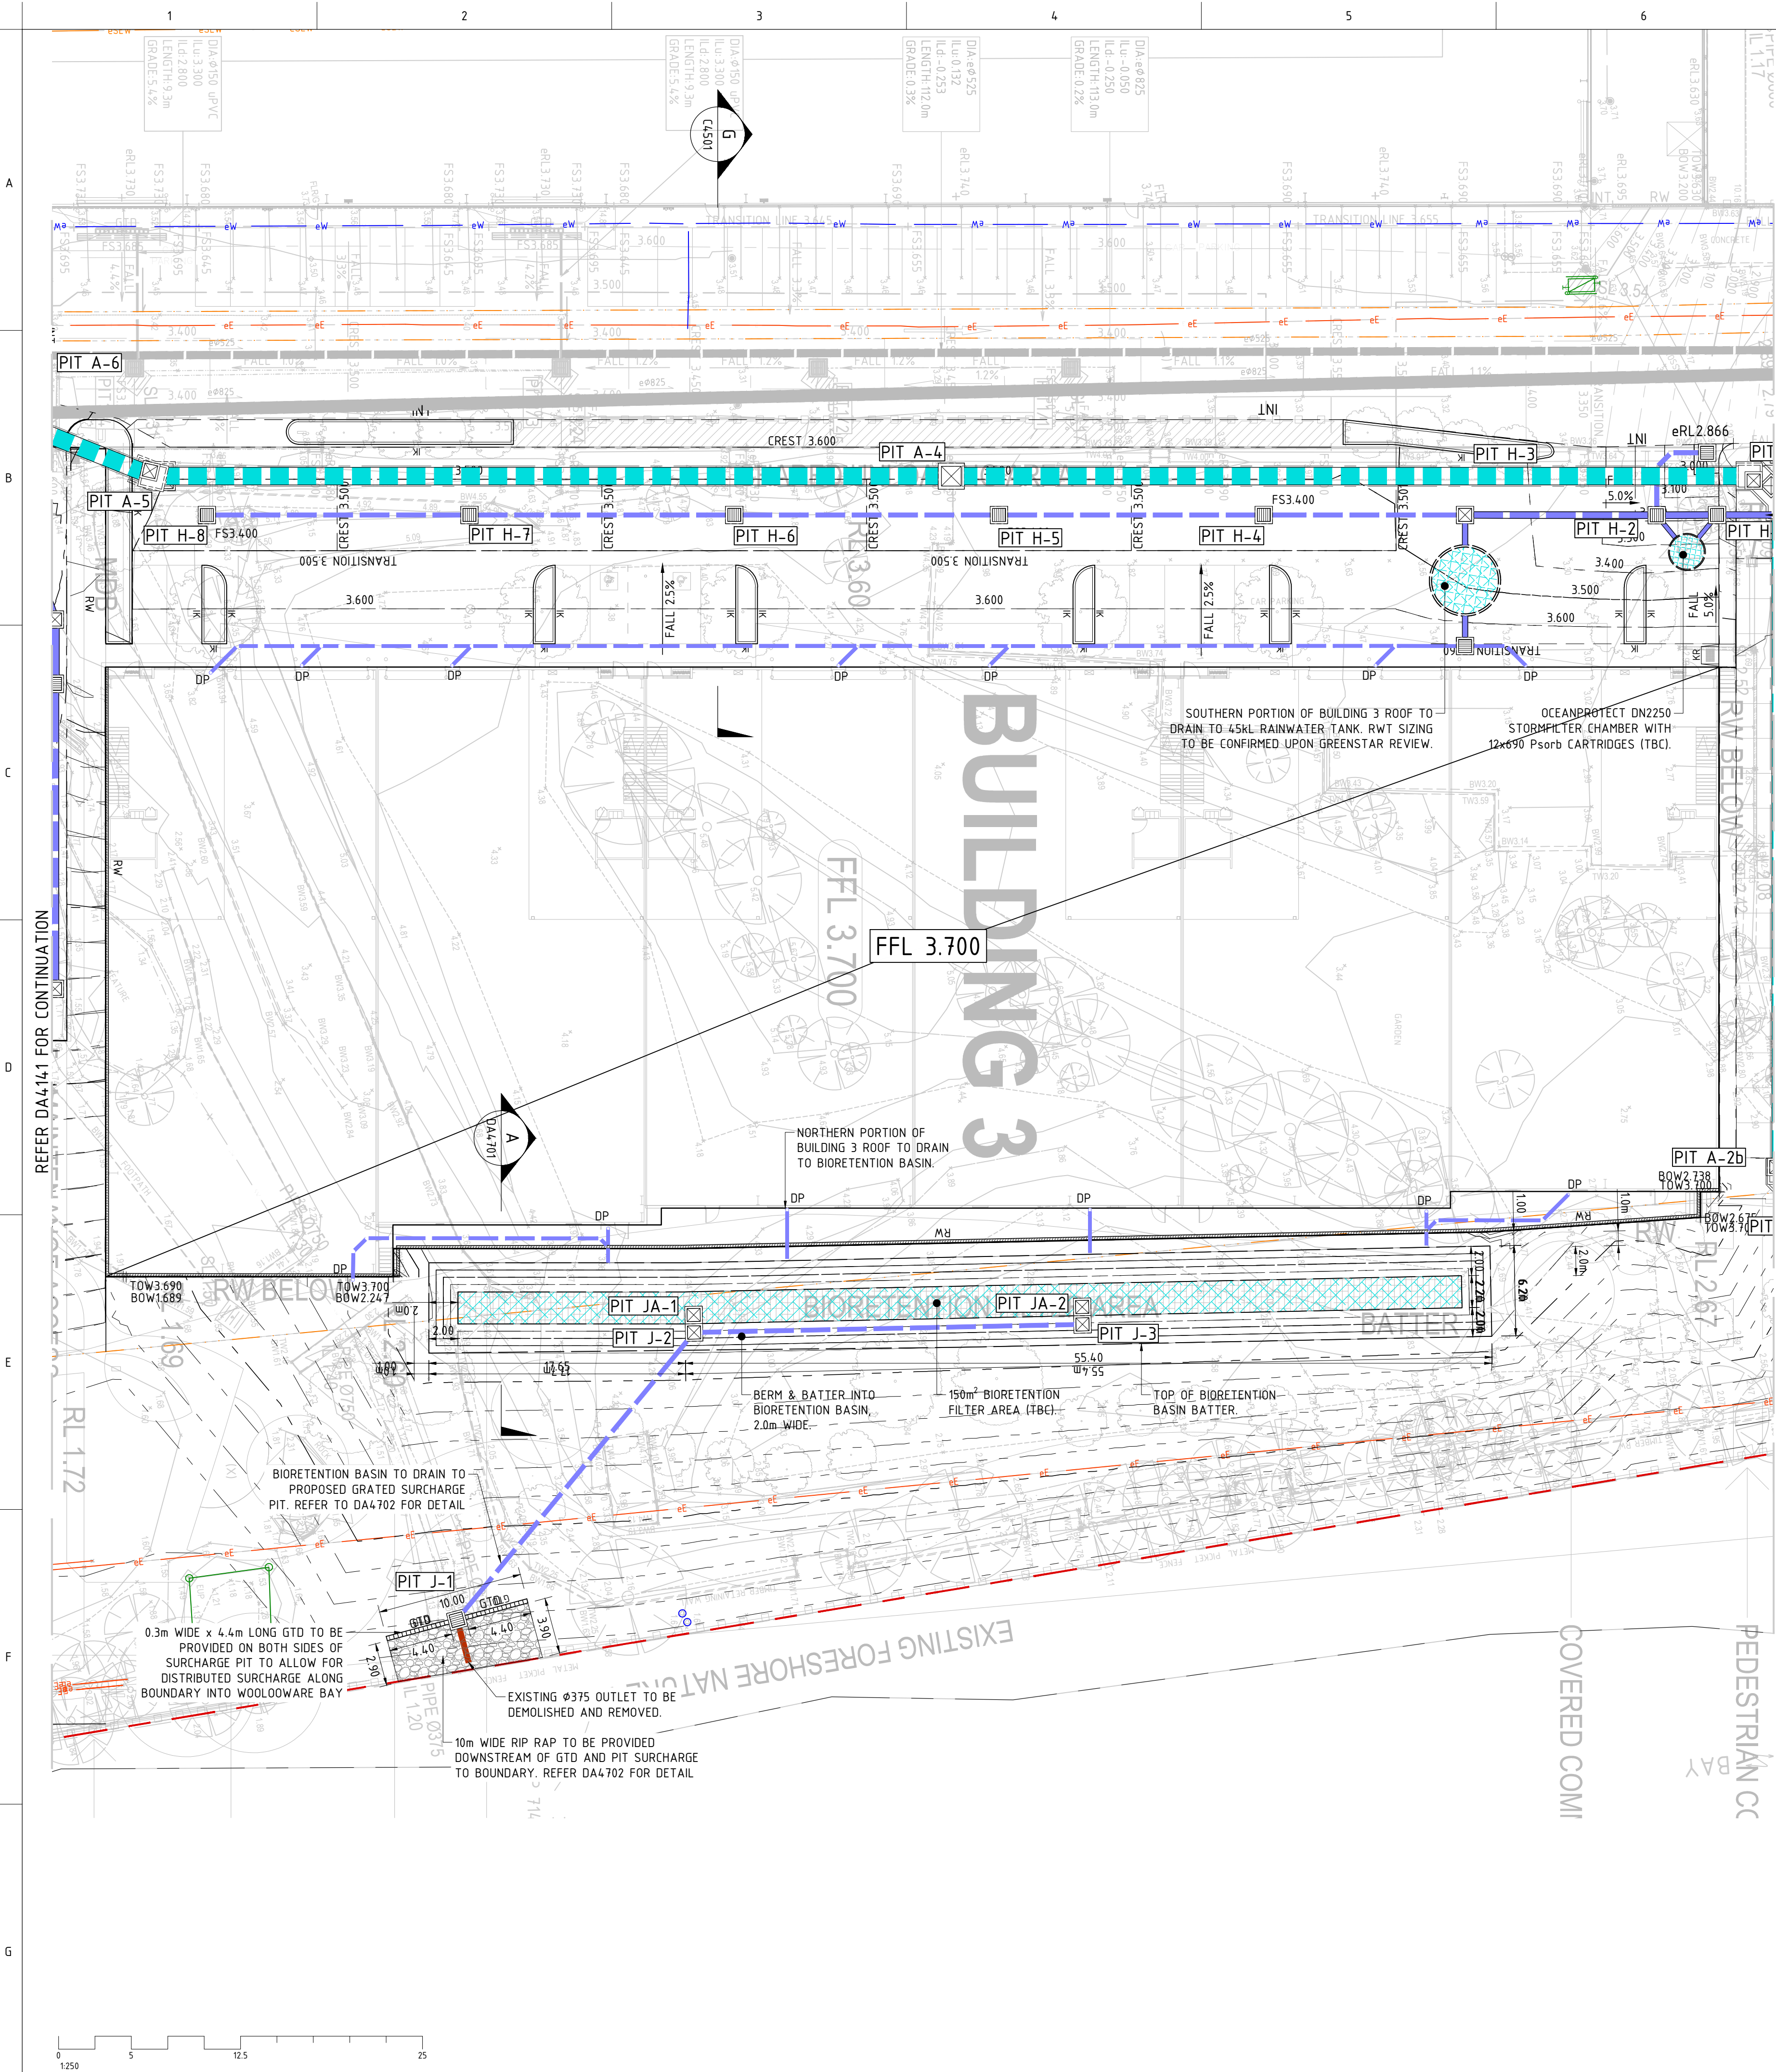
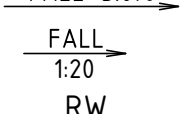
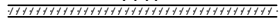
















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DA4-121


DEVELOPMENT APPLICATION ISSUE




LEGEND

	FINISHED SURFACE MAJOR CONTOUR LINE
	FINISHED SURFACE MINOR CONTOUR LINE
	FINISHED SURFACE CREST/TRANSITION LINE
	EXISTING CONTOUR LINE
	FLOOR LEVEL OF EXISTING BUILDING
	FINISHED SURFACE LEVEL
	EXISTING REDUCED SURFACE LEVEL
	TOP OF WALL LEVEL
	BOTTOM OF WALL LEVEL
	TOP OF KERB LEVEL
	INVERT OF KERB LEVEL
	PROPERTY BOUNDARY LINE
	EASEMENT BOUNDARY LINE
	PROPOSED INTEGRAL KERB - REFER DETAIL
	DIRECTION OF SURFACE FALL
	RETAINING WALL
	LIMIT OF WORKS
	PAVEMENT INTERFACE - MATCH NEATLY TO EXISTING LEVELS
	PROPOSED STORMWATER PIPE (≤φ300)
	EXISTING STORMWATER PIPE
	EXISTING STORMWATER PIPE TO BE REMOVED OR REDUNDANT
	PROPOSED STORMWATER BOX CULVERT
	DRAINAGE SWALE
	PROPOSED STORMWATER INLET PIT (GRATED COVER)
	PROPOSED STORMWATER JUNCTION PIT (SEALED COVER)
	EXISTING KERB INLET PIT
	EXISTING STORMWATER INLET PIT (LEFT: GRATED COVER - RIGHT:SEALED COVER)
	
	EXISTING STORMWATER PIT TO BE REMOVED
	
	TREATMENT FILTER CHAMBER/DEVICE
	PIPE FLOW DIRECTION AND SIZE

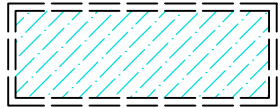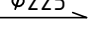[illegible]

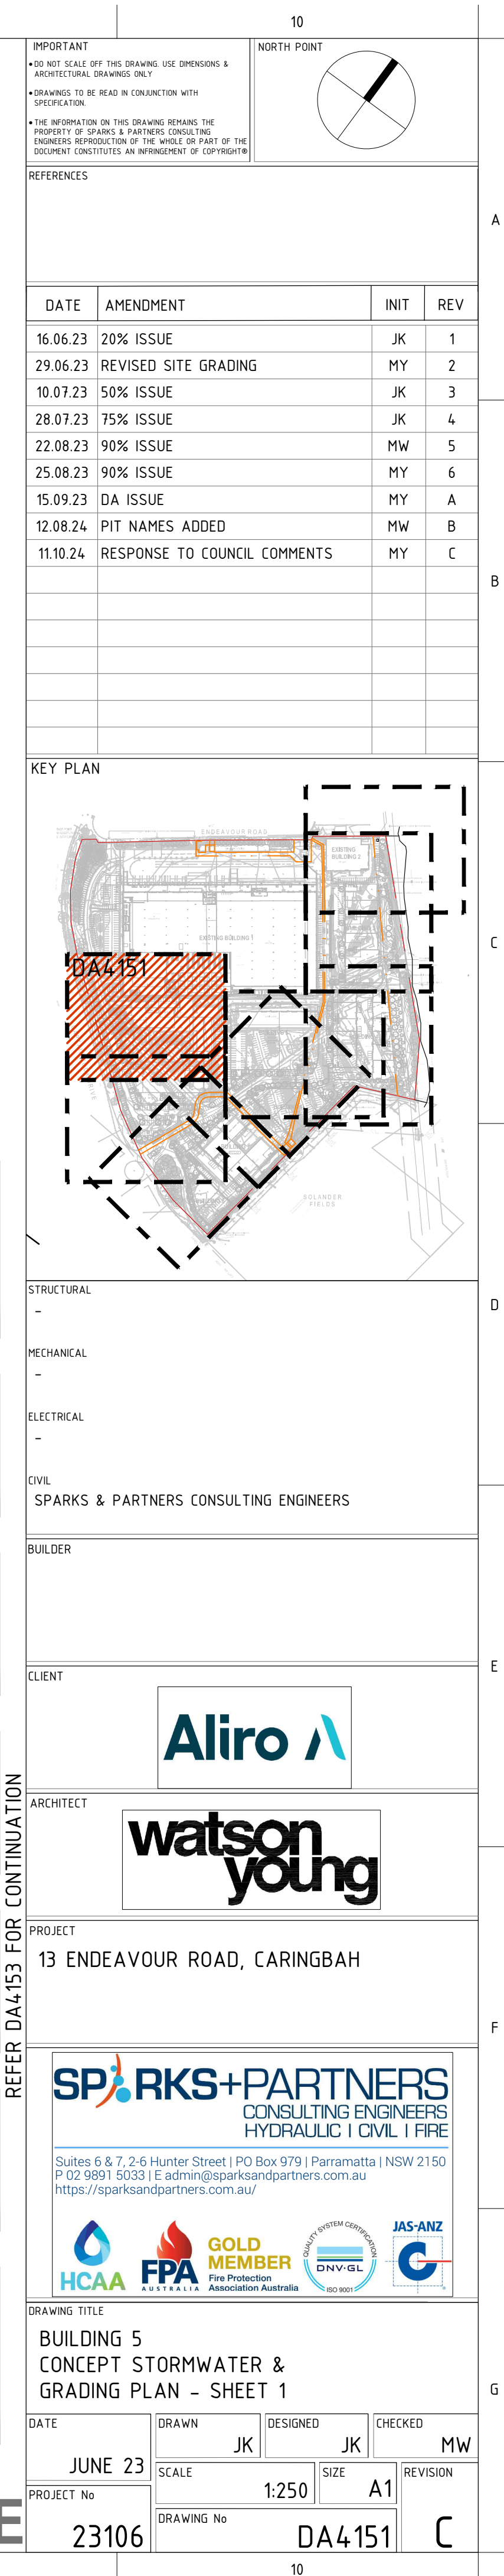

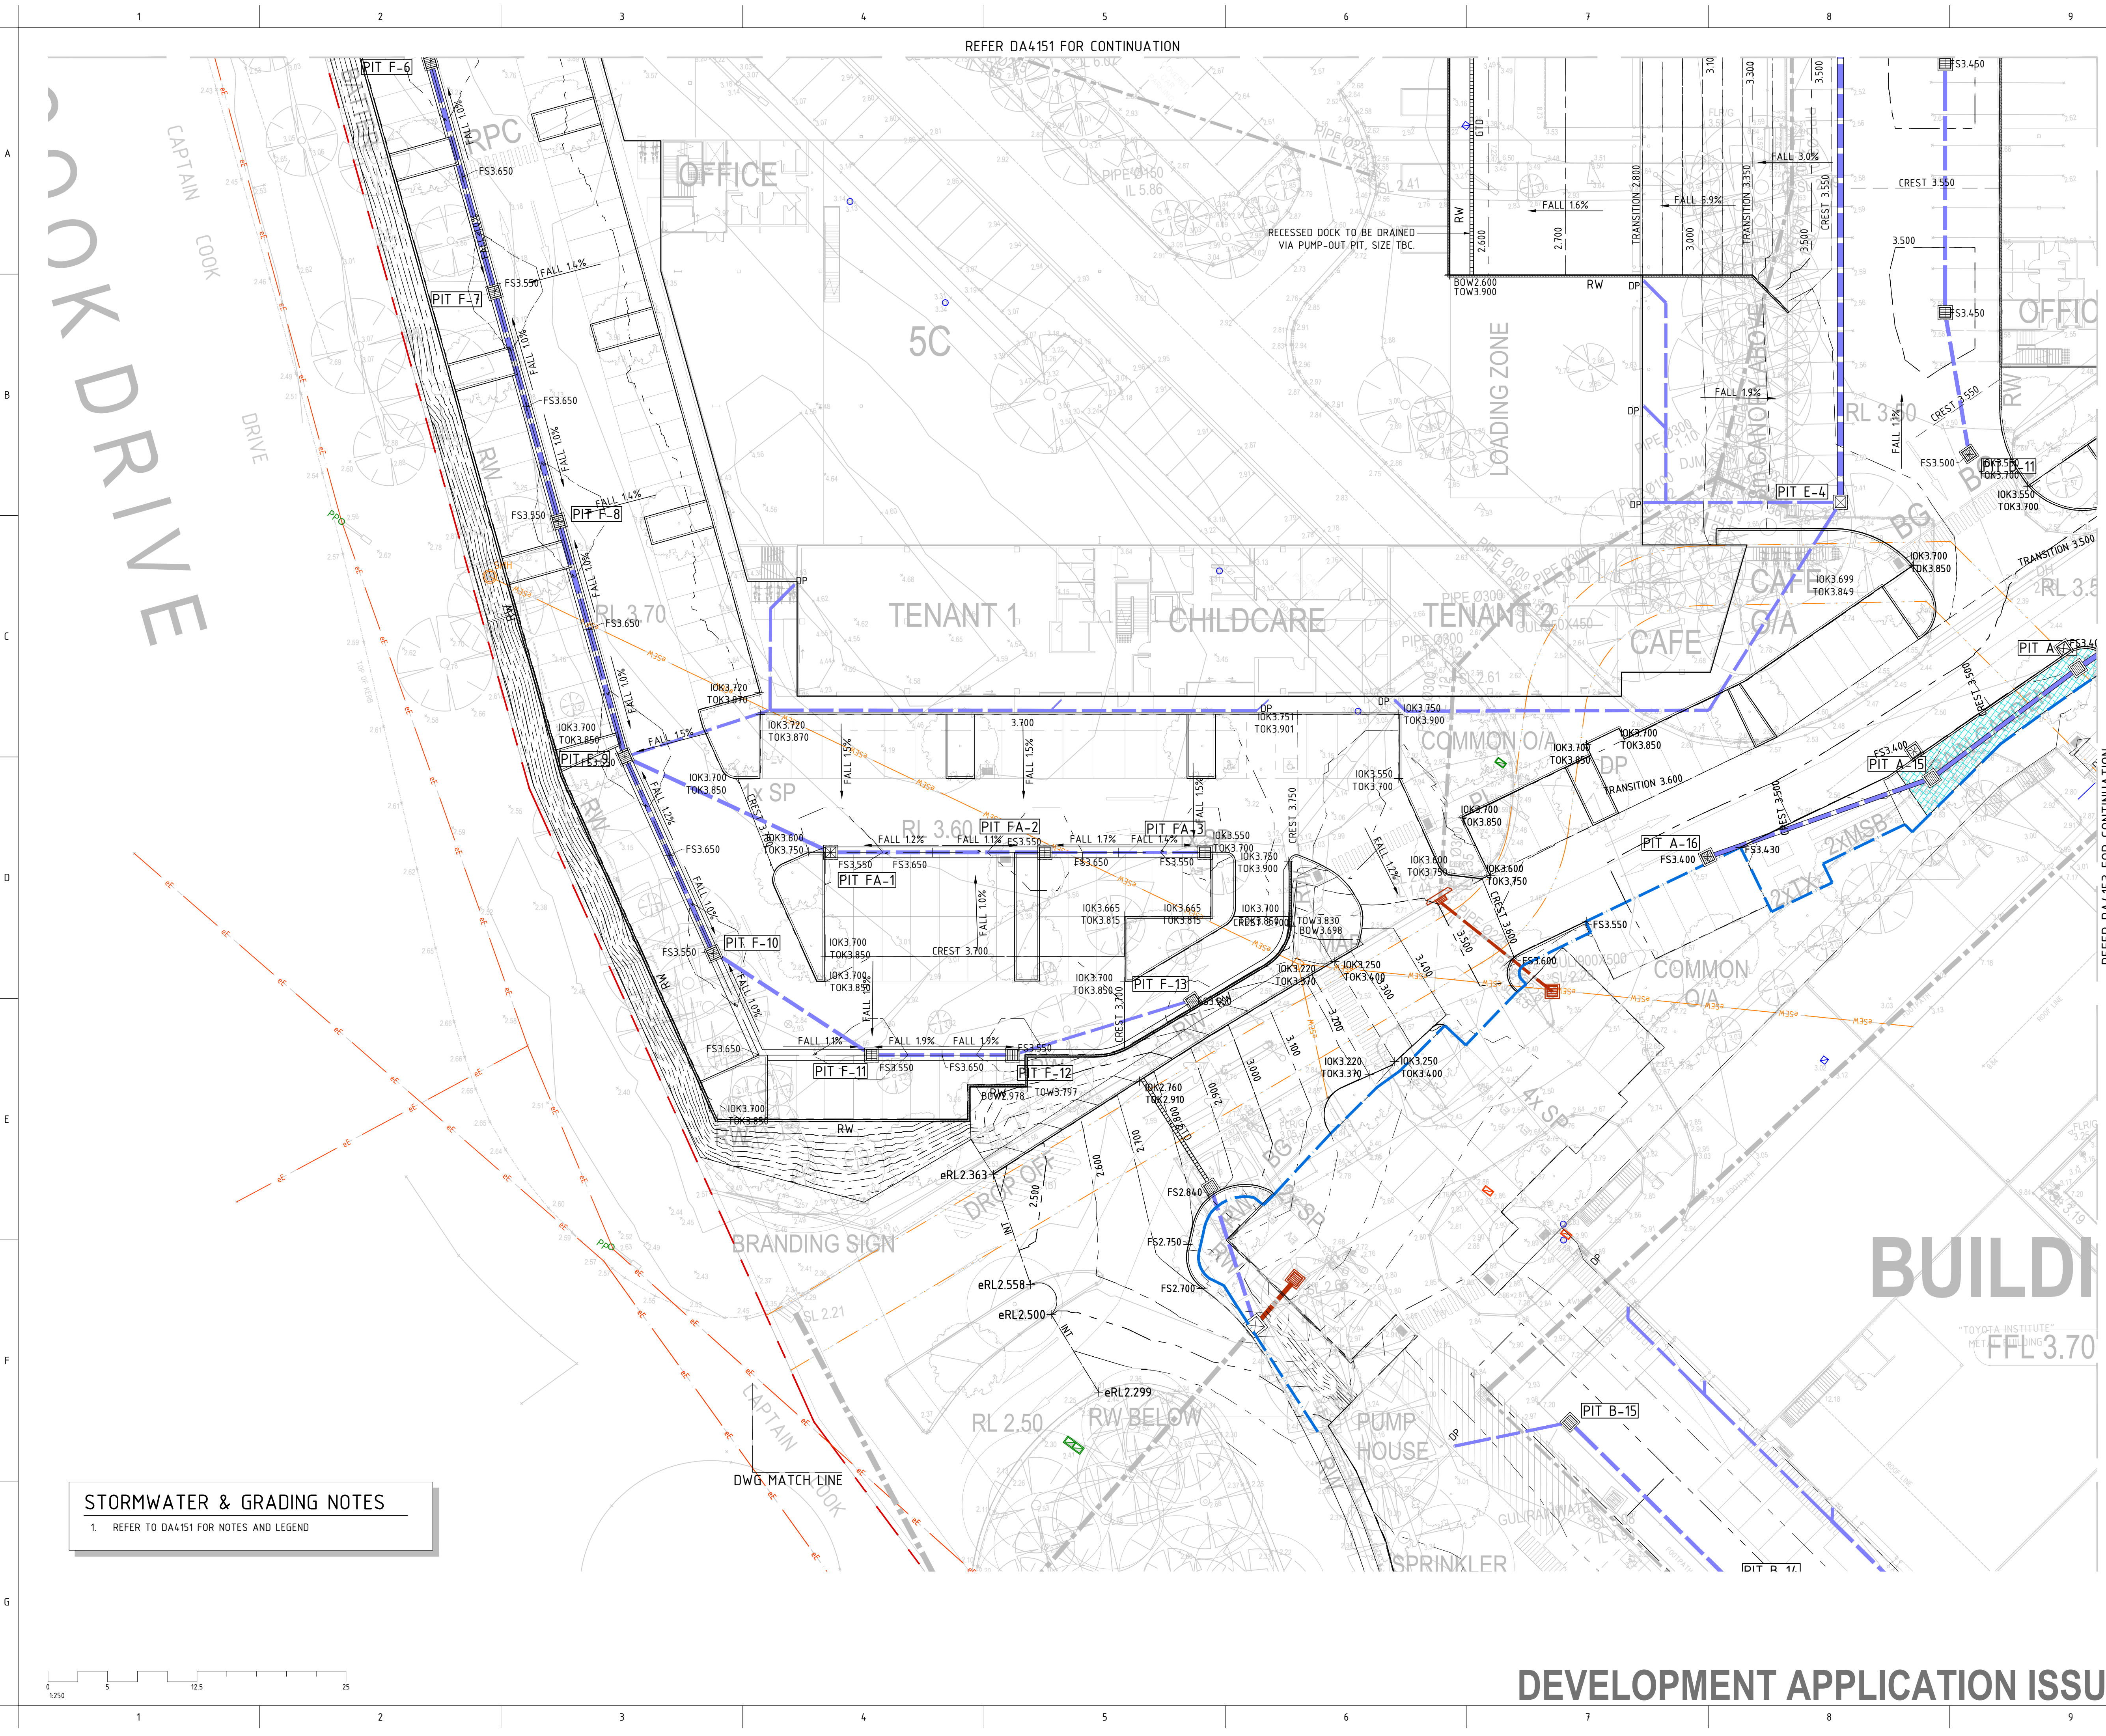

STORMWATER & GRADING NOTES

1. REFER TO DA4151 FOR NOTES AND LEGEND

REFER DA4151 FOR CONTINUATION

REFER DA4153 FOR CONTINUATION

IMPORTANT

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REFERENCES

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29.06.23	REVISED SITE GRADING	MY	2
10.07.23	50% ISSUE	JK	3
28.07.23	75% ISSUE	JK	4
22.08.23	90% ISSUE	MW	5
25.08.23	90% ISSUE	MY	6
15.09.23	DA ISSUE	MY	A
12.08.24	PIT NAMES ADDED	MW	B
11.10.24	RESPONSE TO COUNCIL COMMENTS	MY	C

KEY PLAN

STRUCTURAL

MECHANICAL

ELECTRICAL

CIVIL

SPARKS & PARTNERS CONSULTING ENGINEERS

BUILDER

CLIENT

ARCHITECT

PROJECT

13 ENDEAVOUR ROAD, CARINGBAH

ARCHITECT

Aliro

watson young

PROJECT

13 ENDEAVOUR ROAD, CARINGBAH

ARCHITECT

SPARKS+PARTNERS
CONSULTING ENGINEERS
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HCAA FPA GOLD MEMBER JAS-ANZ
Fire Protection Association Australia

DRAWING TITLE


BUILDING 5
CONCEPT STORMWATER &
GRADING PLAN - SHEET 2

DATE	DRAWN	DESIGNED	CHECKED	MW
JUNE 23	JK	JK	JK	MW

PROJECT No	SCALE	SIZE	REVISION
23106	1:250	A1	REVISION

DRAWING No	DA4152
C	

DEVELOPMENT APPLICATION ISSUE

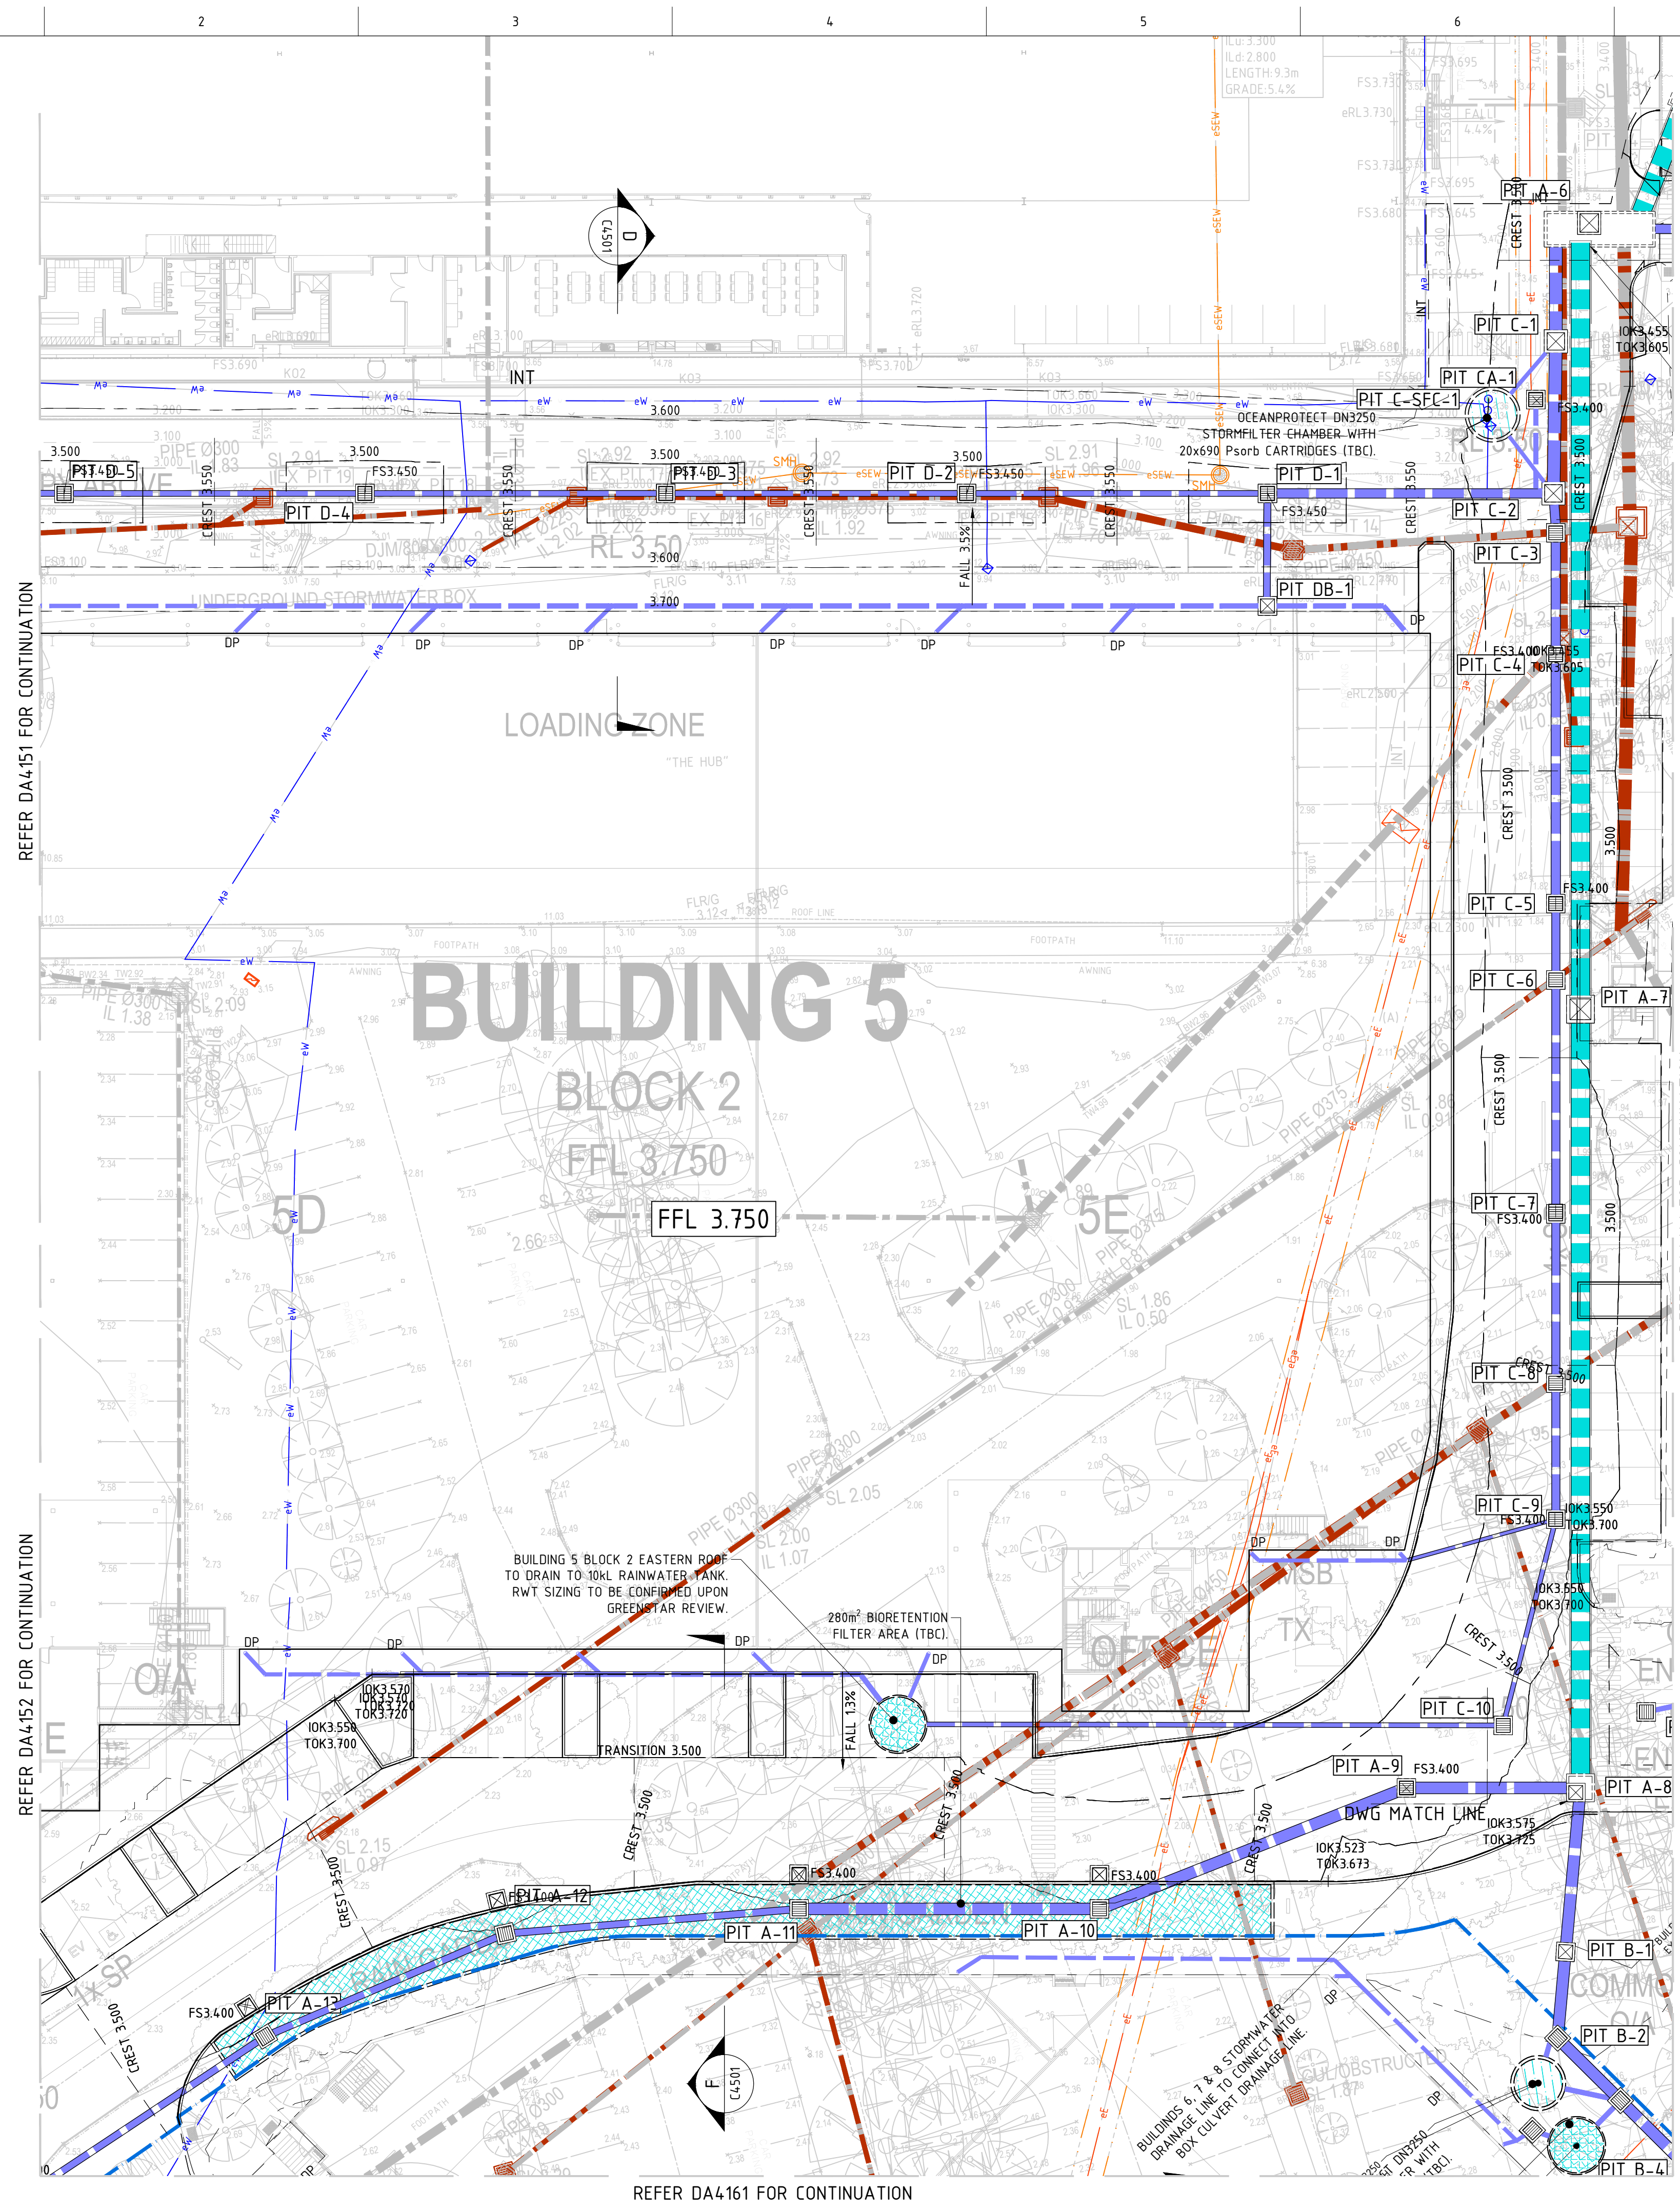

STORMWATER & GRADING NOTES

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DATE

AMENDMENT

INIT

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12.08.24	PIT NAMES ADDED	MW	B
11.10.24	RESPONSE TO COUNCIL COMMENTS	MY	C

KEY PLAN

STRUCTURAL

MECHANICAL

ELECTRICAL

CIVIL

SPARKS & PARTNERS CONSULTING ENGINEERS

BUILDER

CLIENT

Aliro

ARCHITECT

watson young

PROJECT

13 ENDEAVOUR ROAD, CARINGBAH


DRAWING TITLE

BUILDING 5
CONCEPT STORMWATER &
GRADING PLAN - SHEET 3

DATE	DRAWN	DESIGNED	CHECKED
JUNE 23	JK	JK	MW

PROJECT No	SCALE	SIZE	REVISION
23106	1:250	A1	

DRAWING No	DA4153
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LEGEND

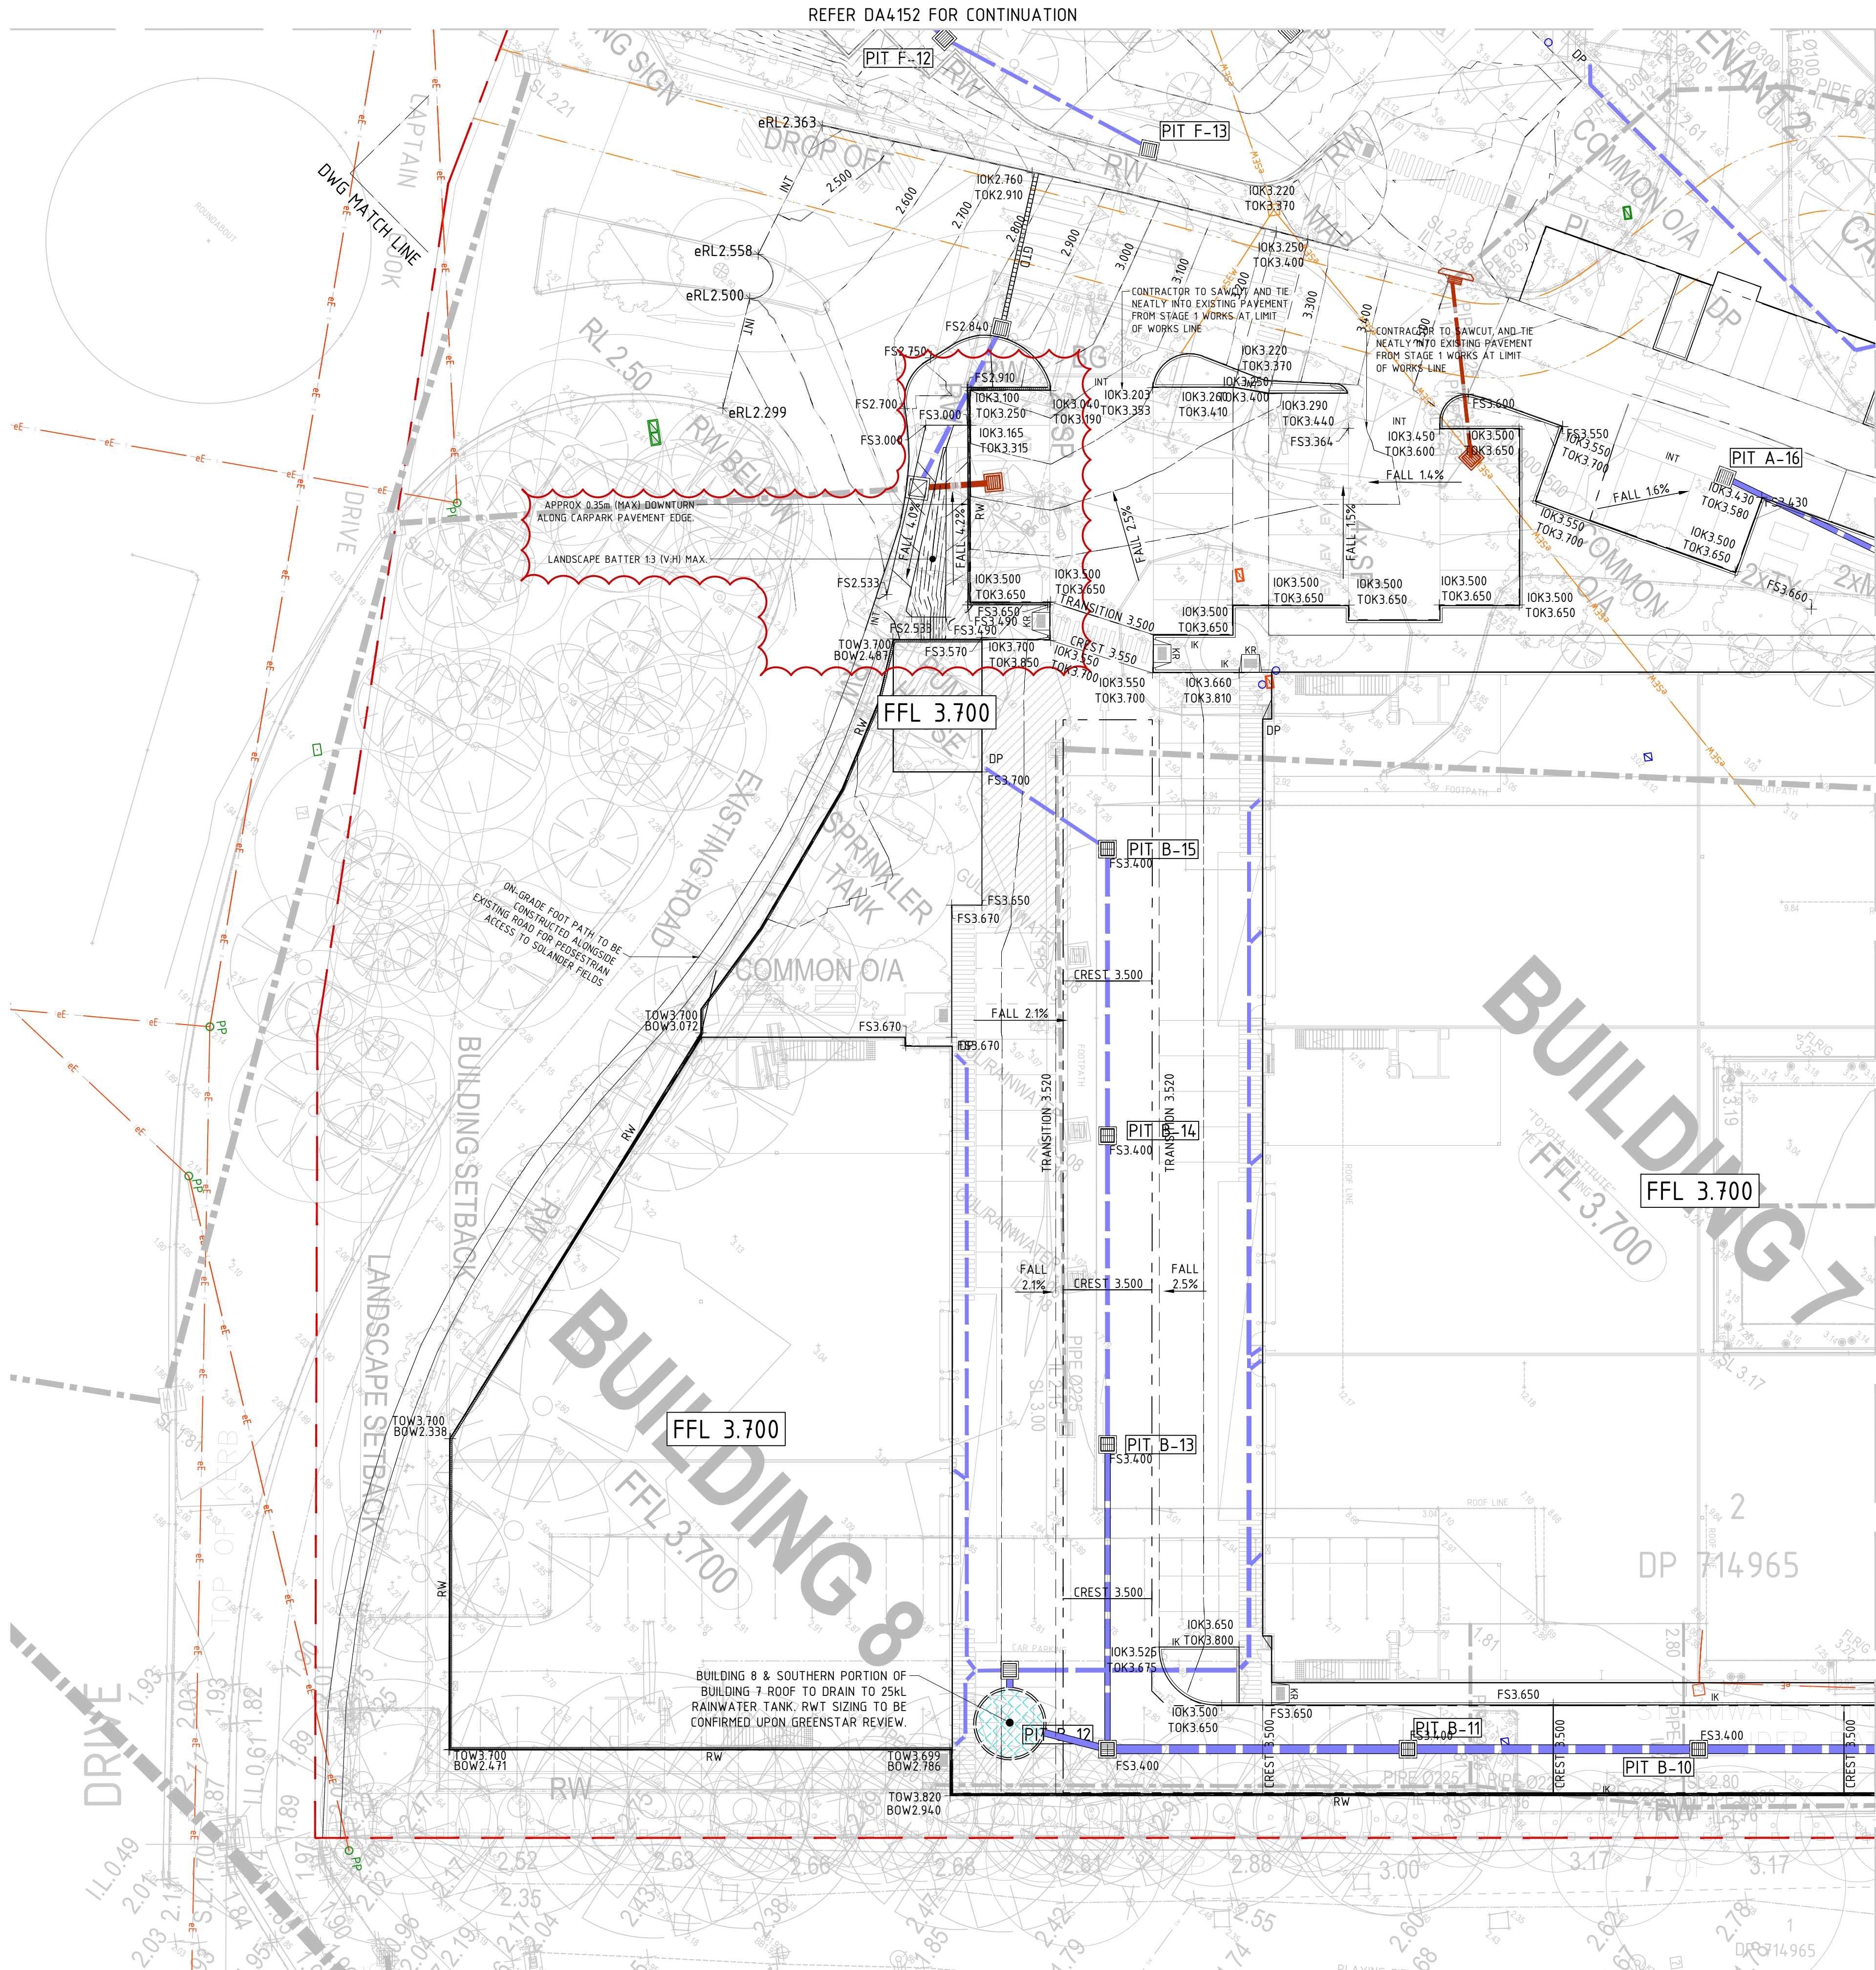20.000

—

FINISHED SURFACE MAJOR CONTOUR LINE

20.100

—

FINISHED SURFACE MINOR CONTOUR LINE

20.150

—

FINISHED SURFACE CREST/TRANSITION LINE

20.100

—

EXISTING CONTOUR LINE

exFL 25.000

+

FLOOR LEVEL OF EXISTING BUILDING

+ FS55.555

+

FINISHED SURFACE LEVEL

+ eRL55.555

+

EXISTING REDUCED SURFACE LEVEL

+ TOW55.555

+

TOP OF WALL LEVEL

+ BOW55.555

+

BOTTOM OF WALL LEVEL

+ TOK55.555

+

TOP OF KERB LEVEL

+ IOK55.555

+

INVERT OF KERB LEVEL

— — —

—

PROPERTY BOUNDARY LINE

— — —

—

EASEMENT BOUNDARY LINE

— — —

—

PROPOSED INTEGRAL KERB - REFER DETAIL

FALL 5.0%

FALL

1:20

RW

DIRECTION OF SURFACE FALL

— — —

—

RETAINING WALL

— — —

—

LIMIT OF WORKS

— — —

—

PAVEMENT INTERFACE - MATCH NEATLY TO EXISTING LEVELS

— — —

—

PROPOSED STORMWATER PIPE (ø300)

— — —

—

EXISTING STORMWATER PIPE

— — —

—

EXISTING STORMWATER PIPE TO BE REMOVED OR REDUNDANT

— — —

—

PROPOSED STORMWATER BOX CULVERT

— — —

—

DRAINAGE SWALE

— — —

—

PROPOSED STORMWATER INLET PIT (GRATED COVER)

— — —

—

PROPOSED STORMWATER JUNCTION PIT (SEALED COVER)

— — —

—

EXISTING KERB INLET PIT

— — —

—

EXISTING STORMWATER INLET PIT (LEFT: GRATED COVER - RIGHT:SEALED COVER)

— — —

—

EXISTING STORMWATER PIT TO BE REMOVED

— — —

—

TREATMENT FILTER CHAMBER/DEVICE

— — —

—

PIPE FLOW DIRECTION AND SIZE

IMPORTANT

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15.09.23	DA ISSUE	MY	A
12.08.24	PIT NAMES ADDED	MW	B
11.10.24	RESPONSE TO COUNCIL COMMENTS	MY	C

KEY PLAN

STRUCTURAL

-

MECHANICAL

-

ELECTRICAL

-

CIVIL

SPARKS & PARTNERS CONSULTING ENGINEERS

BUILDER

CLIENT

ARCHITECT

PROJECT

13 ENDEAVOUR ROAD, CARINGBAH

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DRAWING TITLE

BUILDING 6 7 8
CONCEPT STORMWATER & GRADING PLANS - SHEET 1

DATE

JUNE 23

SCALE

1:250

SIZE

A1

REVISION

PROJECT No

23106

DRAWING No

DA4161

DESIGNED

JK

CHECKED

JK

APPROVED

MW

DEVELOPMENT APPLICATION ISSUE

1 2 3 4 5 6 7 8 9 10

A

B


C

D

E

F

G

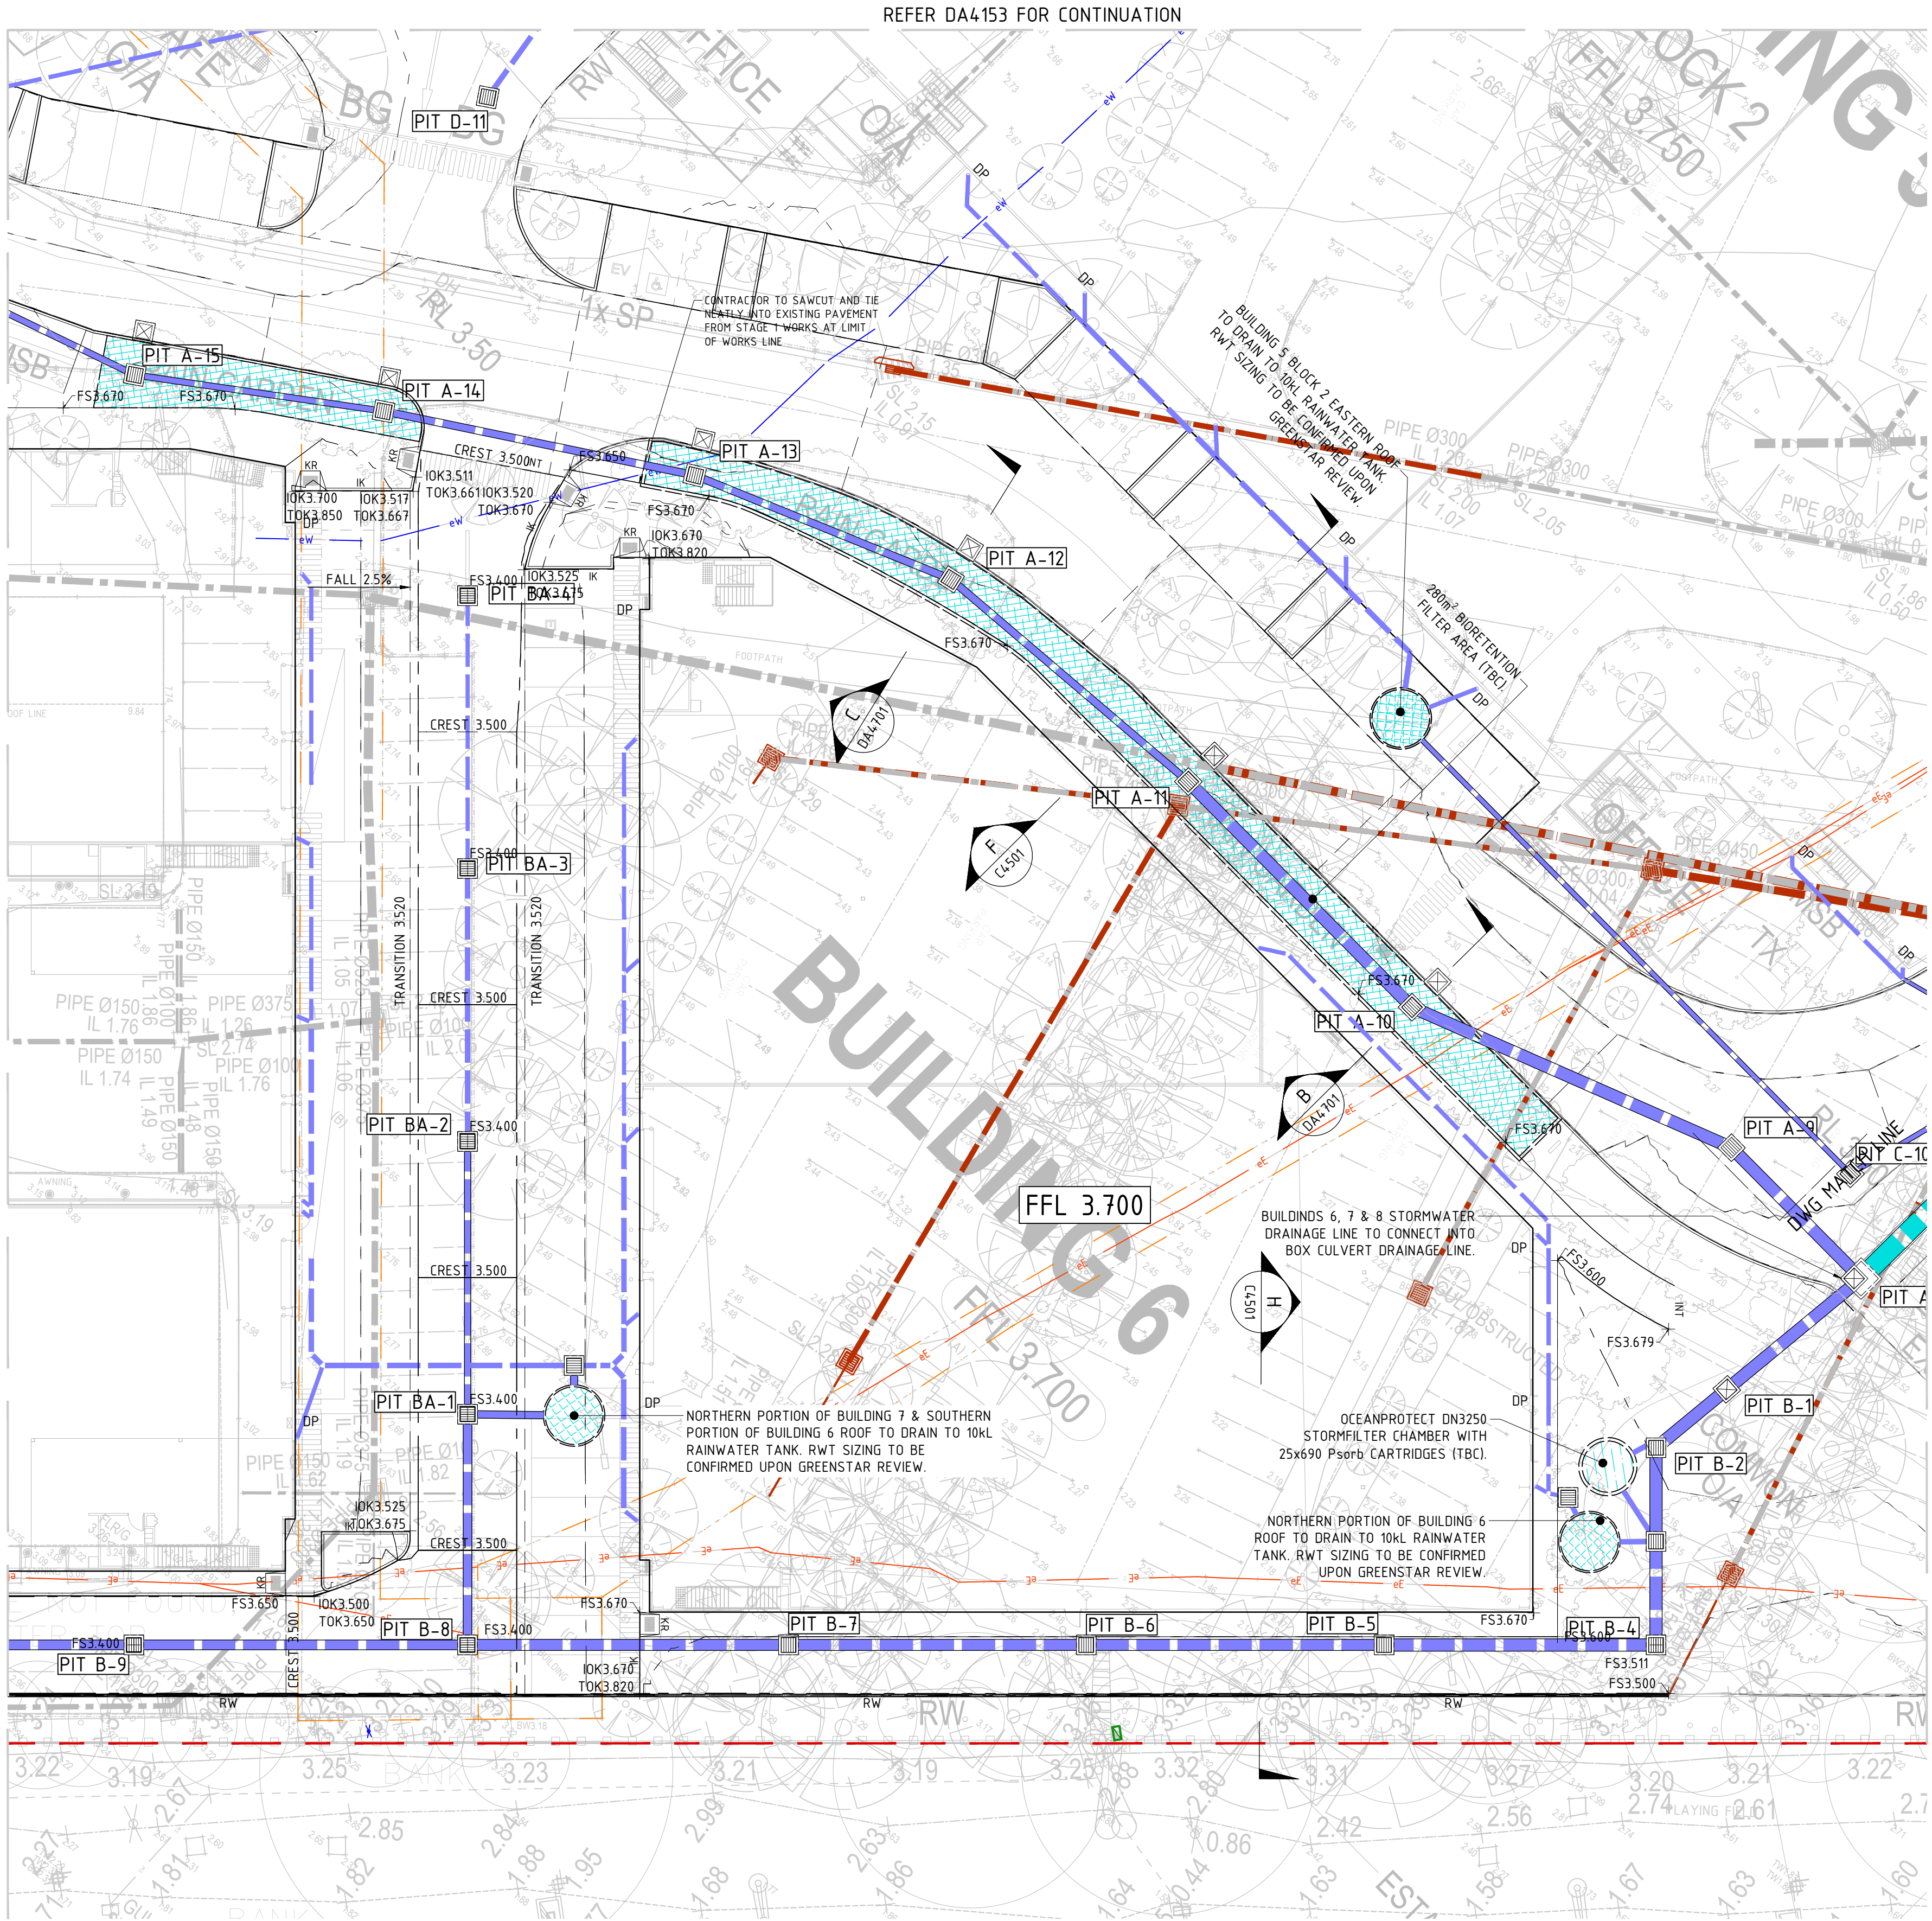

DEVELOPMENT APPLICATION ISSUE

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22.08.23	90% ISSUE	MW	5
25.08.23	90% ISSUE	MY	6
15.09.23	DA ISSUE	MY	A
12.08.24	PIT NAMES ADDED	MW	B
11.10.24	RESPONSE TO COUNCIL COMMENTS	MY	C

KEY PLAN

STRUCTURAL

-

MECHANICAL

-

ELECTRICAL

-

CIVIL

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DRAWING TITLE

BUILDING 6 7 8
CONCEPT STORMWATER &
GRADING PLANS - SHEET 2

DATE

JUNE 23

DESIGNED

JK

CHECKED

JK

REVISION

MW

PROJECT No

23106

SCALE

1:250

SIZE

A1

DRAWING No

DA4162

C

A

B

C

D

E


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G




LEGEND


BUILDING 2 CATCHMENT AREAS

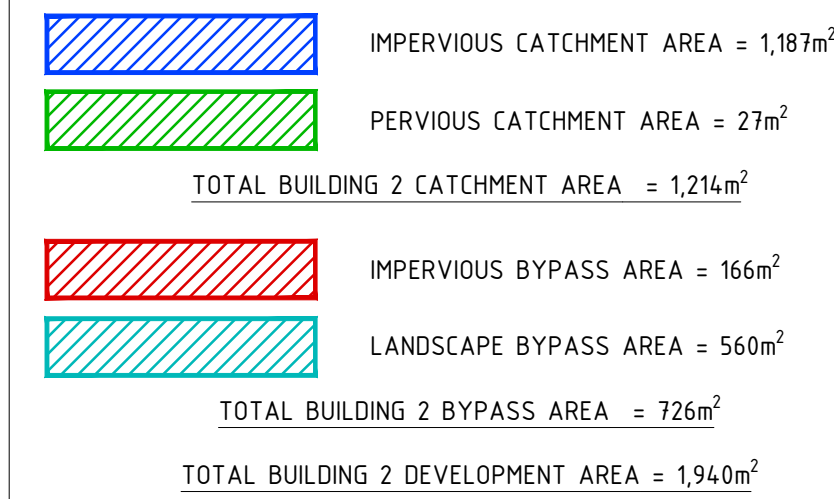

BUILDING 3 CATCHMENT AREAS

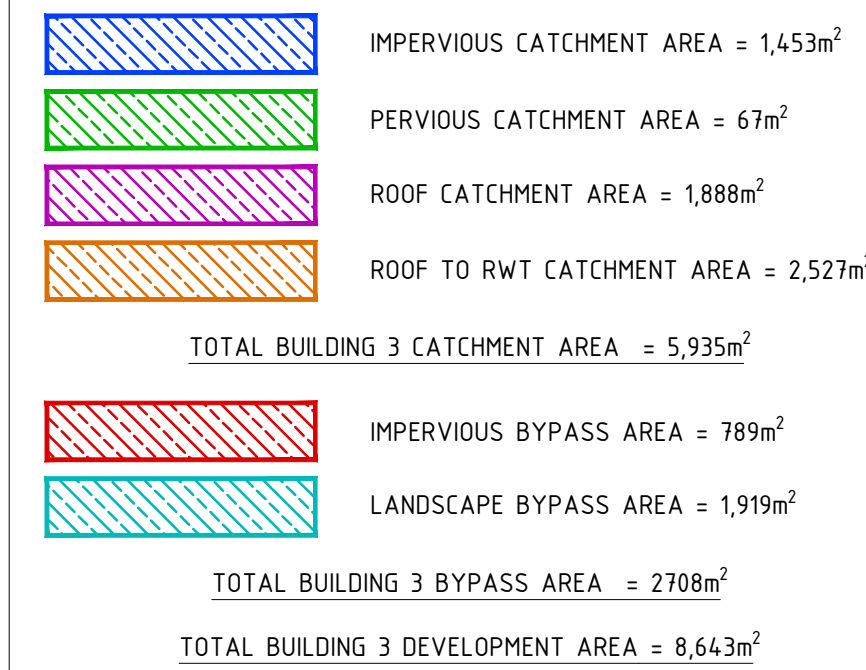


BUILDING 4 CATCHMENT AREAS

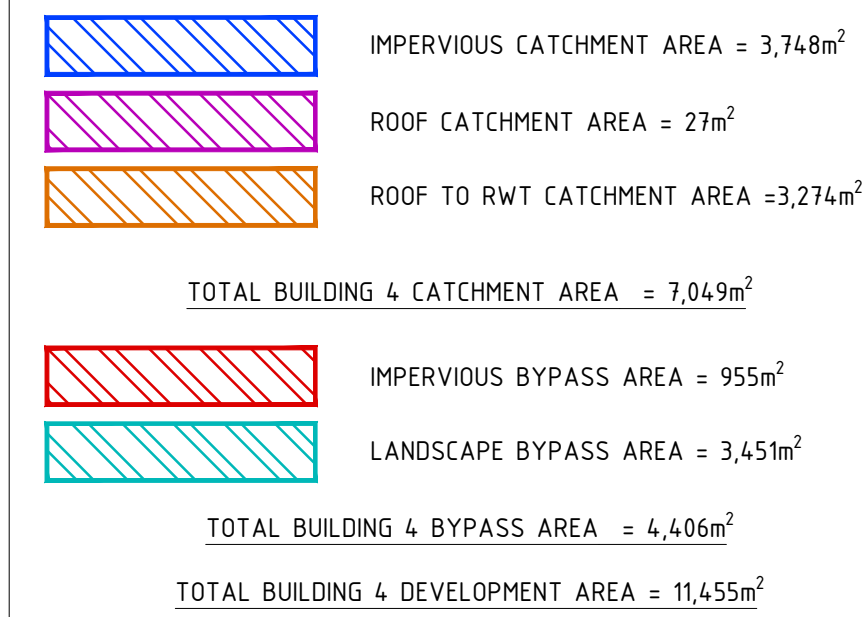


LEGEND - CONTINUED


BUILDING 5 CATCHMENT AREAS

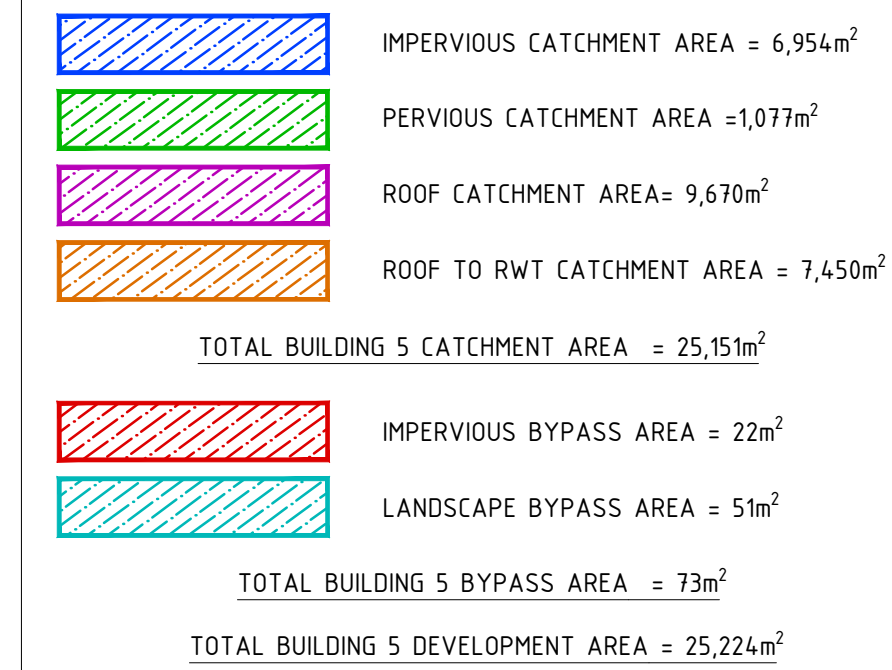


BUILDING 6, 7 & 8 CATCHMENT AREAS

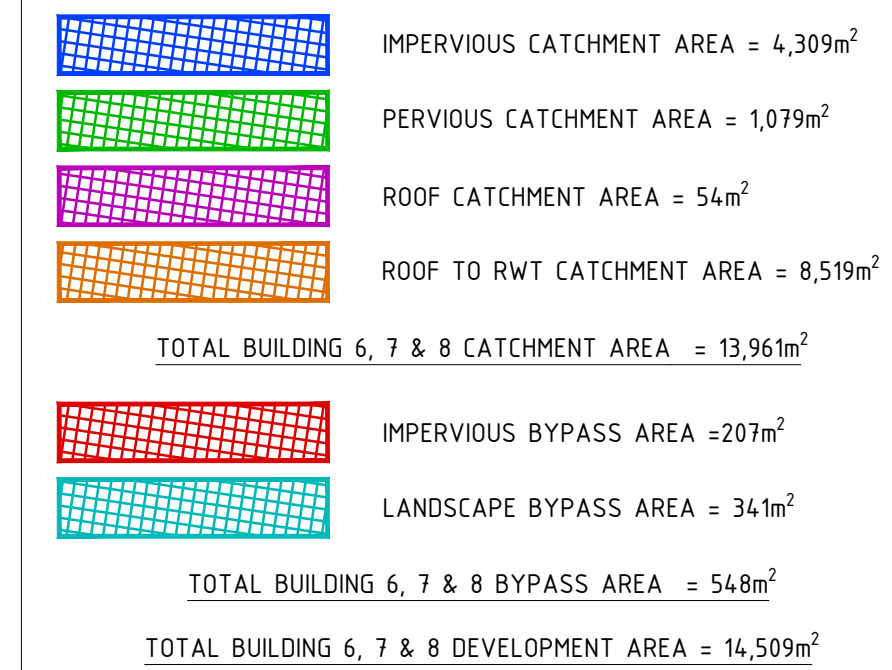

MAIN ROAD CATCHMENT AREAS

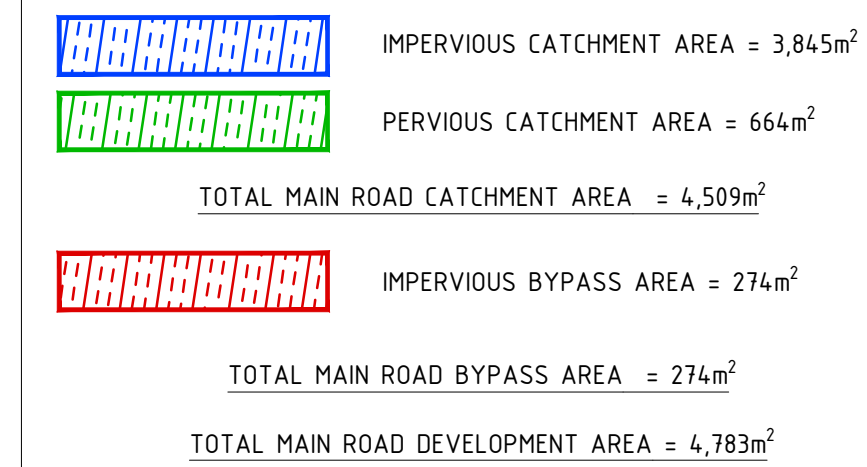

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KEY PLAN

STRUCTURAL
-
MECHANICAL
-
ELECTRICAL
-
CIVIL
SPARKS & PARTNERS CONSULTING ENGINEERS

BUILDER	
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CLIENT

Aliro 

ARCHITECT

**watson
young**

PROJECT
13 ENDEAVOUR ROAD, CARINGBAH


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DRAWING TITLE			
MASTER PLAN CONCEPT STORMWATER CATCHMENT PLAN - GENERAL			
DATE	DRAWN JK	DESIGNED JK	CHECKED MW
JUNE 23	SCALE	1:100	SIZE A1
PROJECT No	DRAWING No		REVISION
23106	DA4301		C

DEVELOPMENT APPLICATION ISSUE



LEGEND	
OUTLET A, BUILDING 5 CATCHMENTS	
	IMPERVIOUS AREA TO FILTER BASKET = 171m ²
	PERVIOUS AREA TO FILTER BASKET = 112m ²
	IMPERVIOUS AREA TO FILTER CHAMBER = 3,367m ²
	PERVIOUS AREA TO FILTER CHAMBER = 359m ²
	ROOF AREA TO FILTER CHAMBER = 519m ²
TOTAL CATCHMENT AREA = 4,527m ²	
OUTLET B, BUILDING 5 CATCHMENTS	
	ROOF AREA TO FILTER CHAMBER = 9,226m ²
TOTAL CATCHMENT AREA = 9,226m ²	
OUTLET C, BUILDING 5 CATCHMENTS	
	IMPERVIOUS AREA TO FILTER CHAMBER = 4,012m ²
	PERVIOUS AREA TO FILTER CHAMBER = 473m ²
	ROOF AREA TO FILTER CHAMBER = 7,344m ²
TOTAL CATCHMENT AREA = 11,829m ²	
OUTLET D, BUILDING 2 CATCHMENTS	
	IMPERVIOUS AREA TO FILTER CHAMBER = 1,208m ²
	PERVIOUS AREA TO FILTER CHAMBER = 31m ²
TOTAL CATCHMENT AREA = 1,239m ²	
	IMPERVIOUS BYPASS AREA = 166m ²
	PERVIOUS BYPASS AREA = 560m ²
TOTAL BYPASS AREA = 726m ²	
OUTLET D, BUILDING 3 CATCHMENTS	
	IMPERVIOUS AREA TO FILTER CHAMBER = 1,440m ²
	PERVIOUS AREA TO FILTER CHAMBER = 67m ²
	ROOF AREA TO FILTER CHAMBER = 2,535m ²
	IMPERVIOUS AREA TO BIO-BASIN = 160m ²
	ROOF AREA TO BIO-BASIN = 1,892m ²
TOTAL CATCHMENT AREA = 6,129m ²	
	IMPERVIOUS BYPASS AREA = 629m ²
	PERVIOUS BYPASS AREA = 1,919m ²
TOTAL BYPASS AREA = 2,548m ²	

LEGEND - CONTINUED	
OUTLET D, BUILDING 4 CATCHMENTS	
	IMPERVIOUS AREA TO FILTER CHAMBER = 3,770m ²
	ROOF AREA TO FILTER CHAMBER = 3,288m ²
TOTAL CATCHMENT AREA = 7,058m ²	
	IMPERVIOUS BYPASS AREA = 955m ²
	PERVIOUS BYPASS AREA = 3,466m ²
TOTAL BYPASS AREA = 4,421m ²	
OUTLET D, BUILDING 6,7,8 CATCHMENTS	
	IMPERVIOUS AREA TO FILTER CHAMBER = 3,219m ²
	PERVIOUS AREA TO FILTER CHAMBER = 922m ²
	ROOF AREA TO FILTER CHAMBER = 8,578m ²
TOTAL CATCHMENT AREA = 12,719m ²	
	IMPERVIOUS BYPASS AREA = 176m ²
	PERVIOUS BYPASS AREA = 245m ²
TOTAL BYPASS AREA = 421m ²	
CAPTAIN COOK DRIVE OUTLET CATCHMENTS	
	IMPERVIOUS AREA TO FILTER BASKET = 907m ²
	PERVIOUS AREA TO FILTER BASKET = 223m ²
	IMPERVIOUS AREA TO BIO-BASIN = 2,004m ²
	ROOF AREA TO BIO-BASIN = 638m ²
TOTAL CATCHMENT AREA = 3,772m ²	
	IMPERVIOUS AREA TO FILTER BASKET = 1,159m ²
	PERVIOUS AREA TO FILTER BASKET = 101m ²
TOTAL CATCHMENT AREA = 1,260m ²	
	IMPERVIOUS BYPASS AREA = 328m ²
	PERVIOUS BYPASS AREA = 151m ²
TOTAL BYPASS AREA = 479m ²	
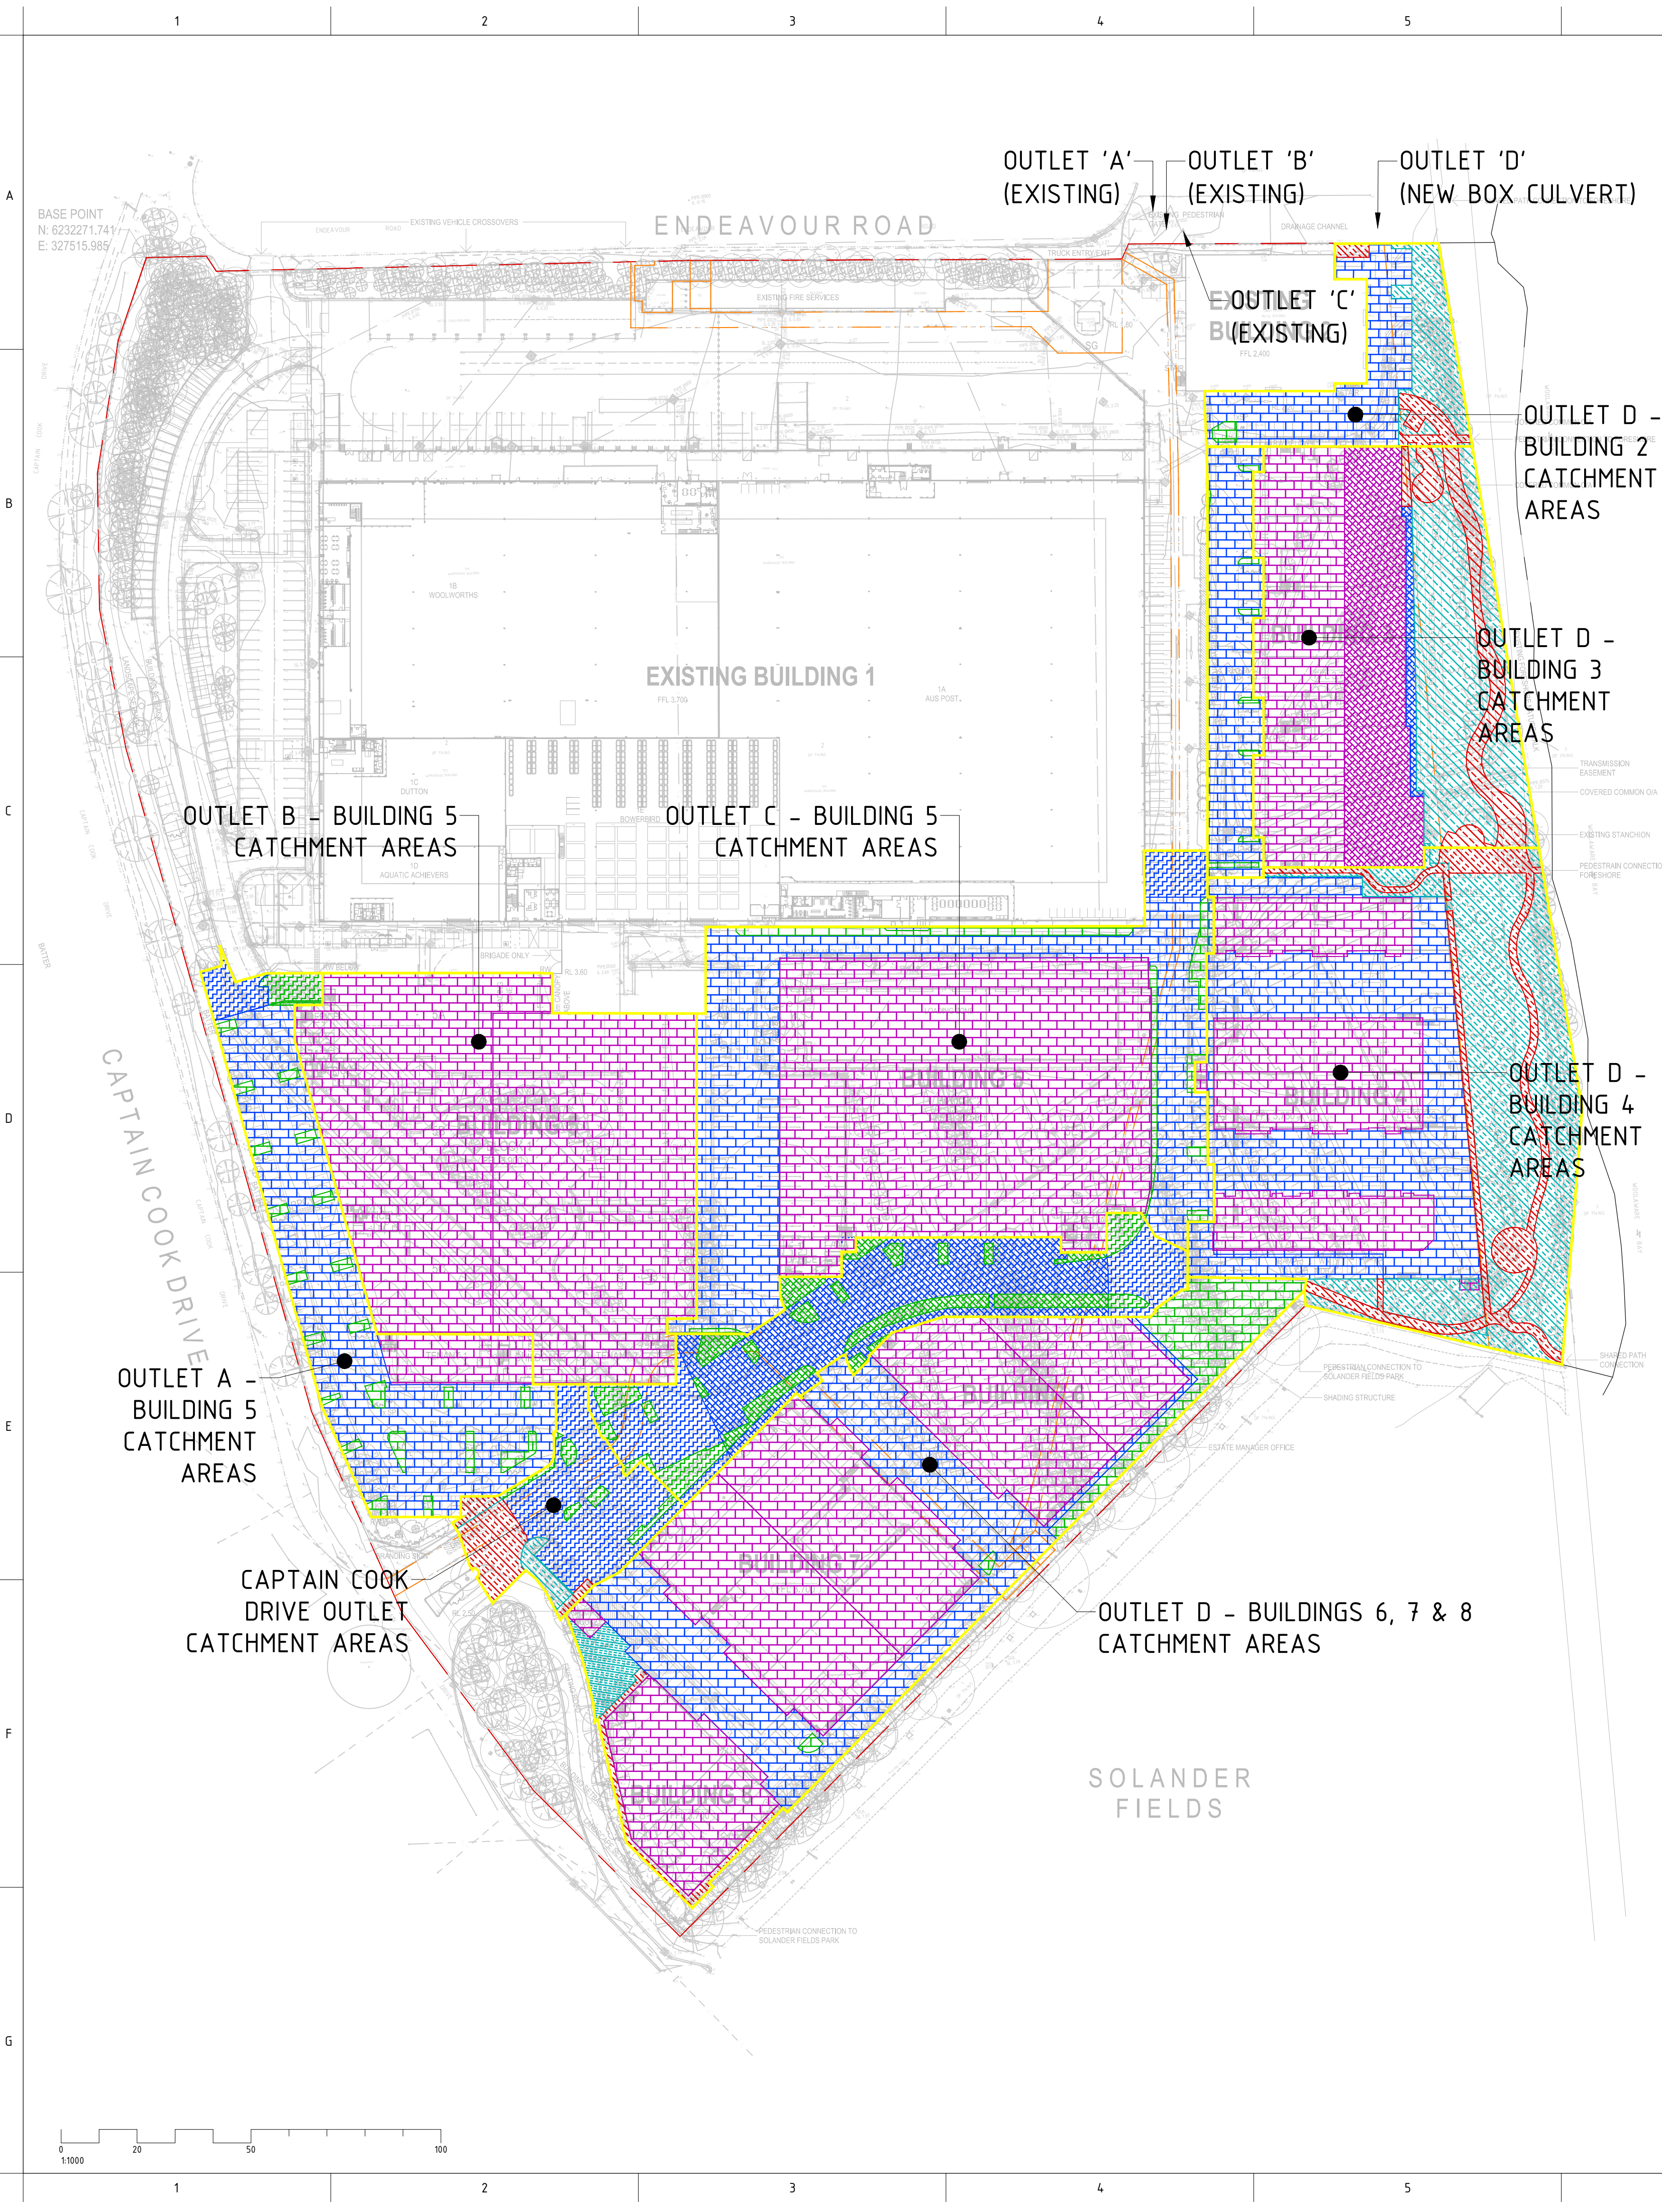
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11.10.24	RESPONSE TO COUNCIL COMMENTS	MY	B
10.02.25	RESPONSE TO COUNCIL COMMENTS	MY	C

KEY PLAN

STRUCTURAL

-

MECHANICAL

-

ELECTRICAL

-

CIVIL

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ARCHITECT

PROJECT

13 ENDEAVOUR ROAD, CARINGBAH

HYDRAULIC | CIVIL | FIRE
Suites 6 & 7, 2-6 Hunter Street | PO Box 979 | Parramatta | NSW 2150
P 02 9891 5033 | E admin@sparksandpartners.com.au
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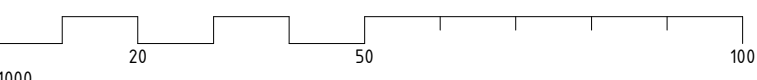
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MASTER PLAN
CONCEPT STORMWATER
CATCHMENT PLAN - WSUD

DATE	DRAWN	DESIGNED	CHECKED	
JUNE 23	JK	JK	MW	
PROJECT No	SCALE	SIZE	REVISION	
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DRAWING No				
	DA4302			




DEVELOPMENT APPLICATION ISSUE

C



DEVELOPMENT APPLICATION ISSUE

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KEY PLAN

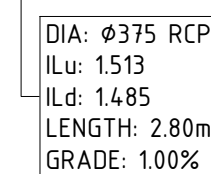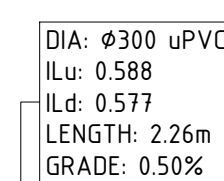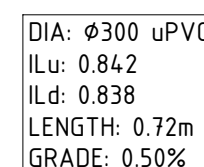STRUCTURAL	
-	
MECHANICAL	
-	
ELECTRICAL	
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CIVIL	
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BUILDER	
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The Aliro logo, featuring the word "Aliro" in a bold, dark blue sans-serif font, followed by a stylized blue icon resembling a mountain peak or a stylized letter 'A'.

ARCHITECT

**watson
young**

PROJECT	13 ENDEAVOUR ROAD, CARINGBAH
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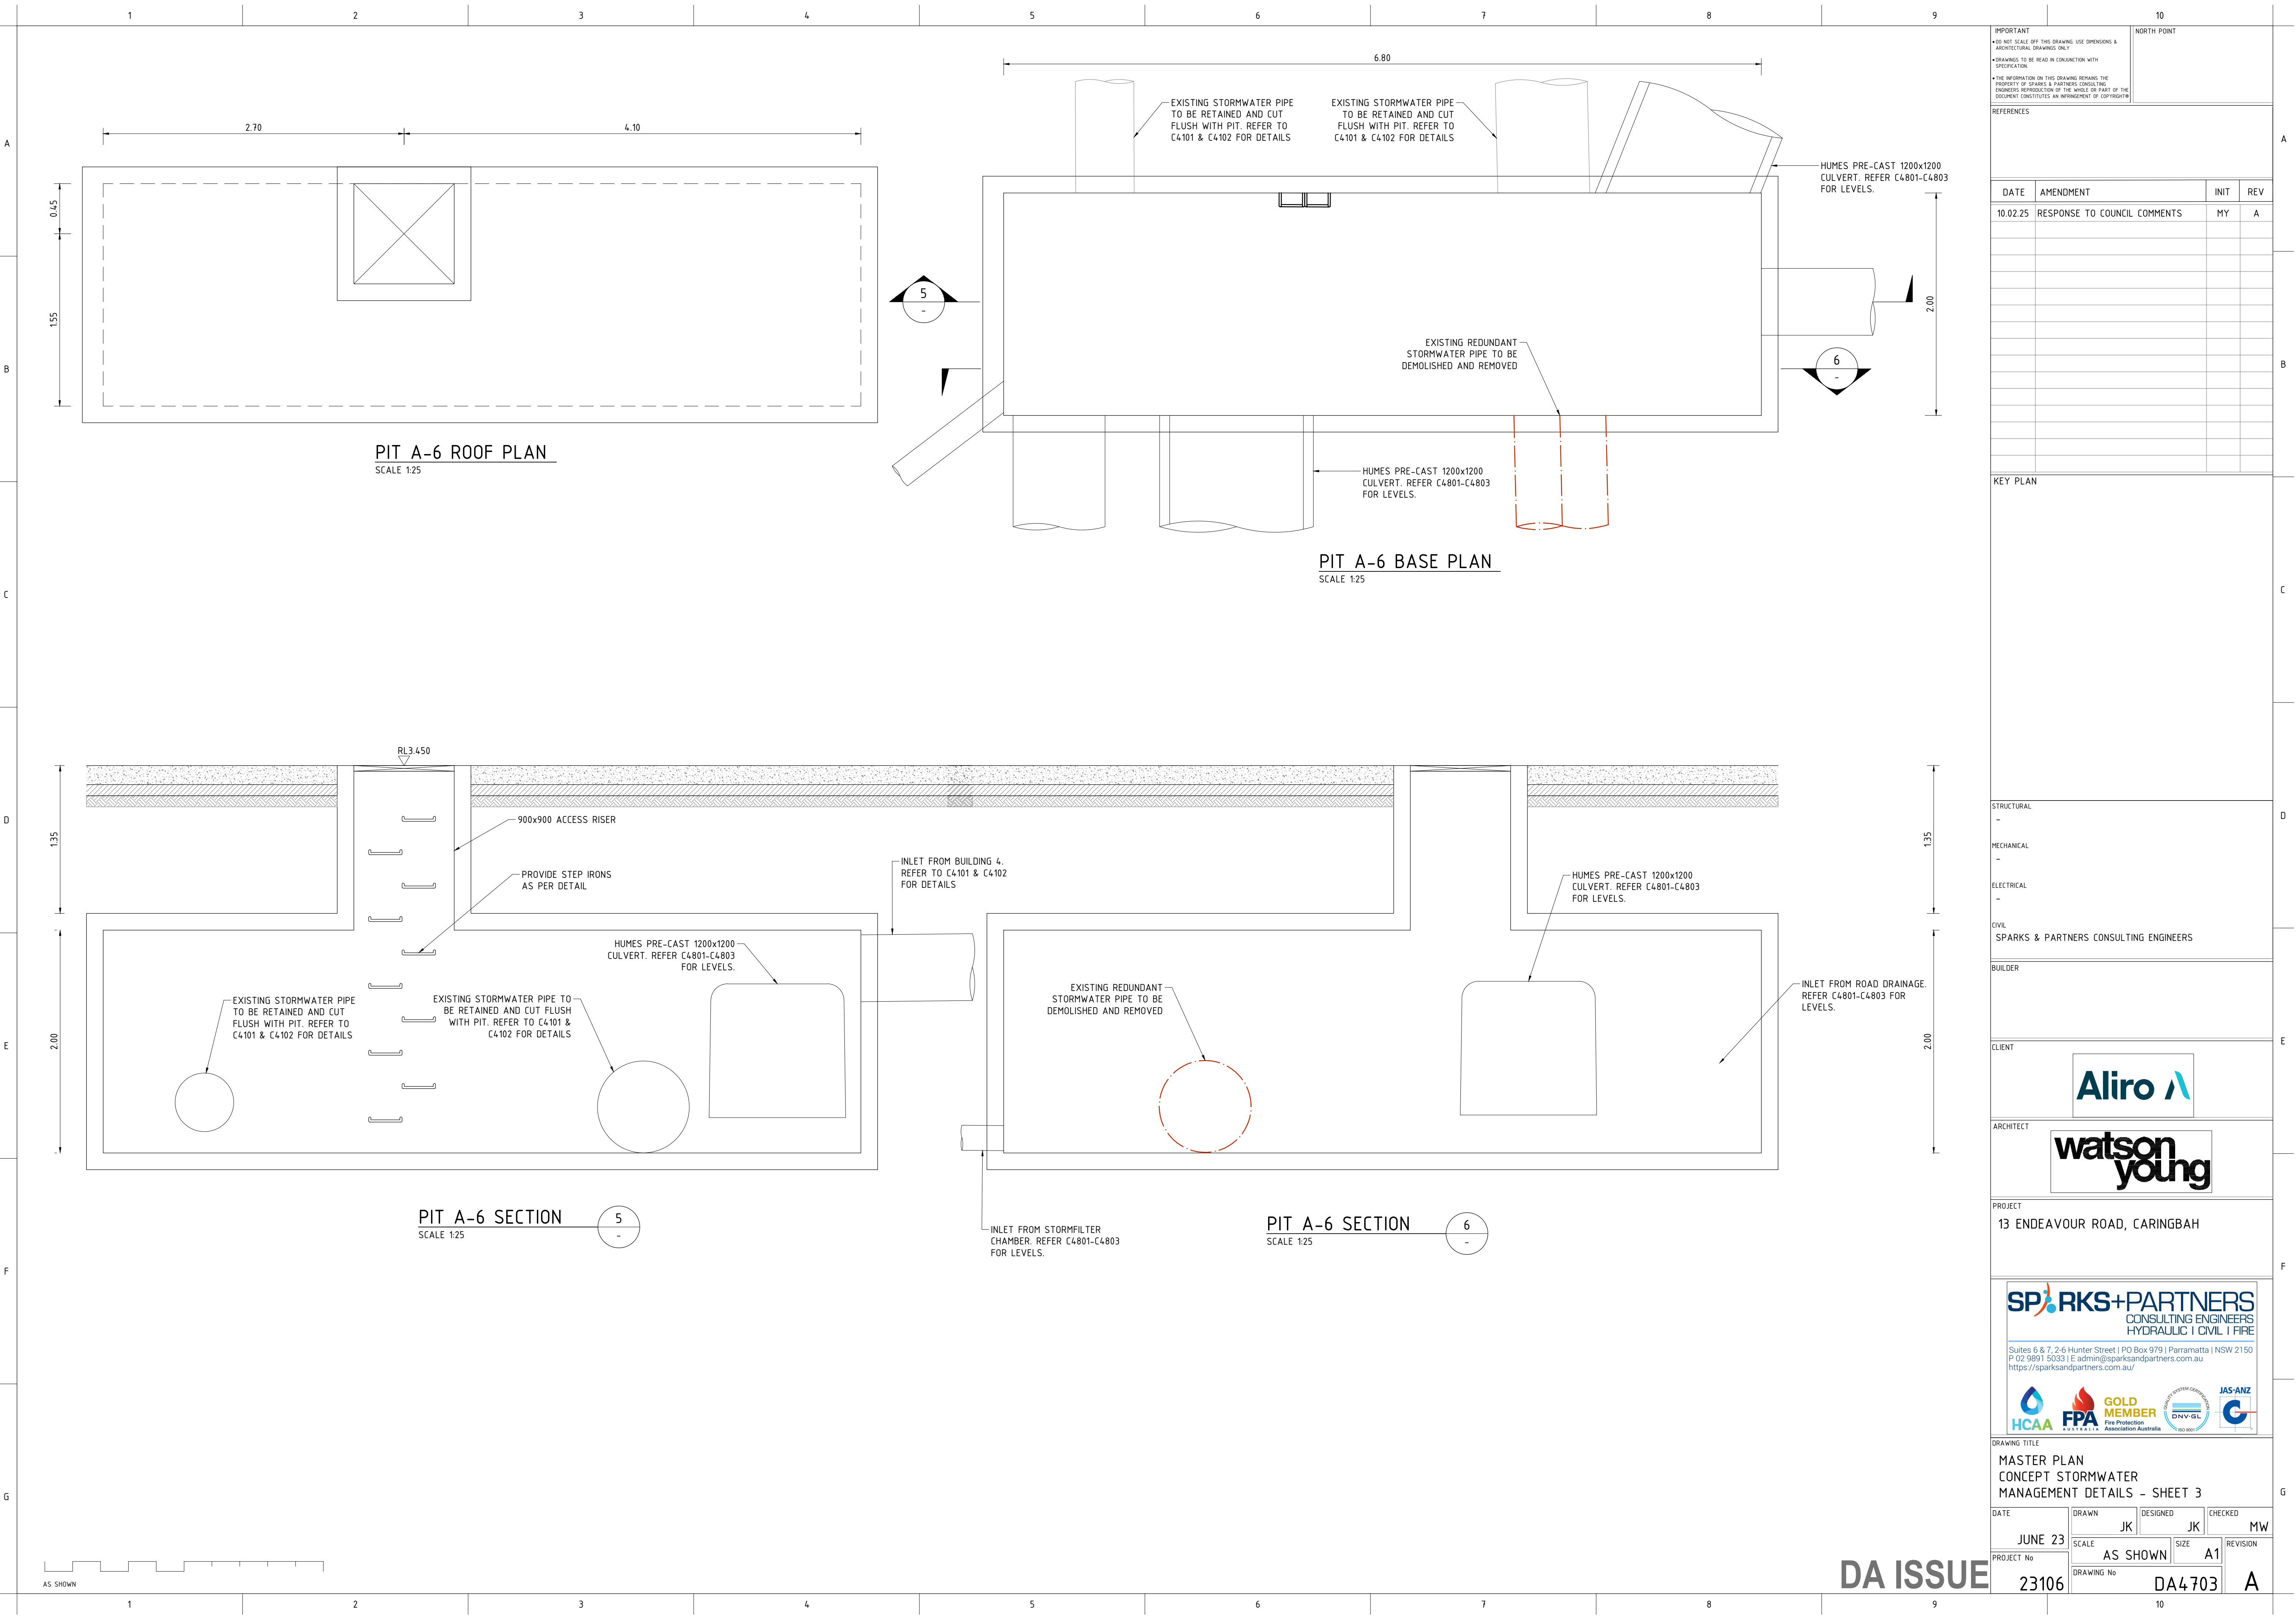
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DRAWING TITLE				
MASTER PLAN CONCEPT STORMWATER MANAGEMENT DETAILS - SHEET 2				
DATE	DRAWN	DESIGNED	CHECKED	
JUNE 23	JK	JK		MW
PROJECT No	SCALE	SIZE	REVISION	
23106	AS SHOWN	A1		
DRAWING No		DA4702		A

DA ISSUE

100



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NORTH POINT

REFERENCES

DATE	AMENDMENT	INIT	REV
10.02.25	RESPONSE TO COUNCIL COMMENTS	MY	A

KEY PLAN

STRUCTURAL

-

MECHANICAL

-

ELECTRICAL

-

CIVIL

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PROJECT

13 ENDEAVOUR ROAD, CARINGBAH

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DRAWING TITLE

MASTER PLAN
CONCEPT STORMWATER
MANAGEMENT DETAILS - SHEET 3

DATE

JUNE 23

SCALE

AS SHOWN

DESIGNED

JK

CHECKED

JK

PROJECT No

23106

SIZE

A1


REVISION

DA ISSUE



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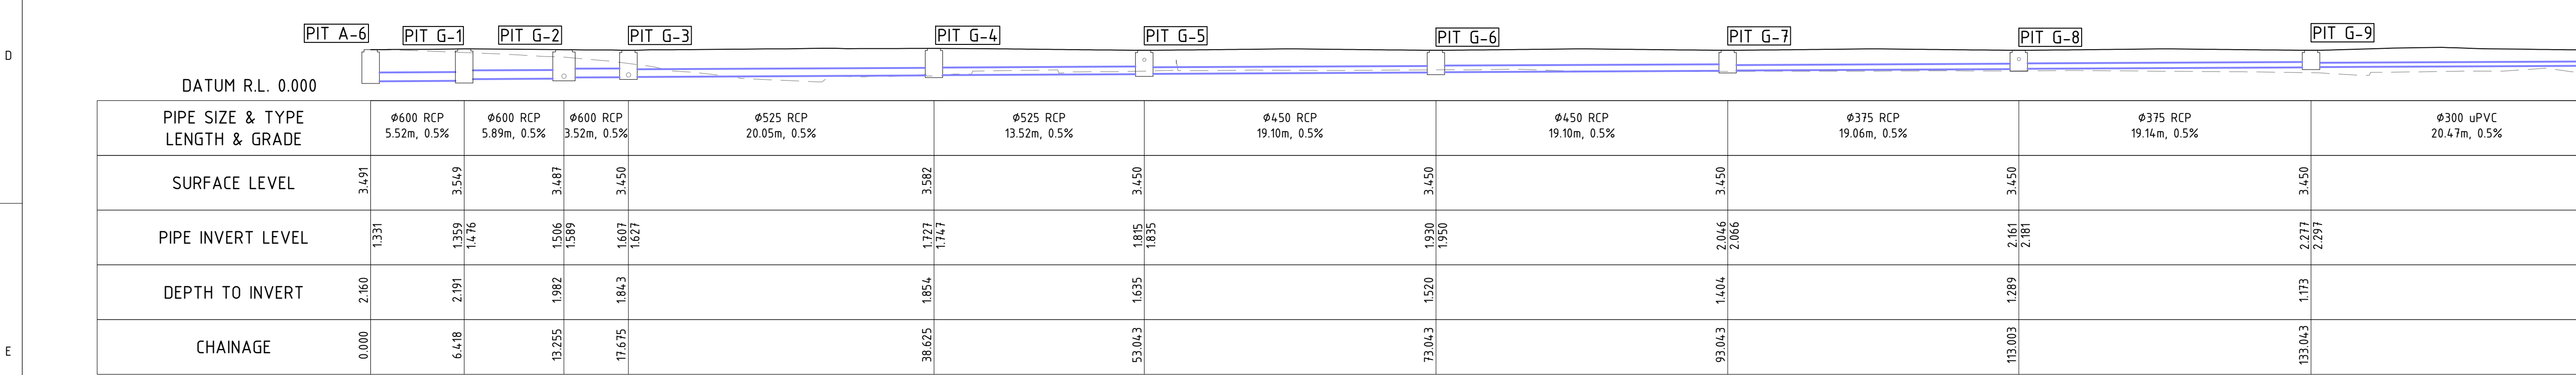
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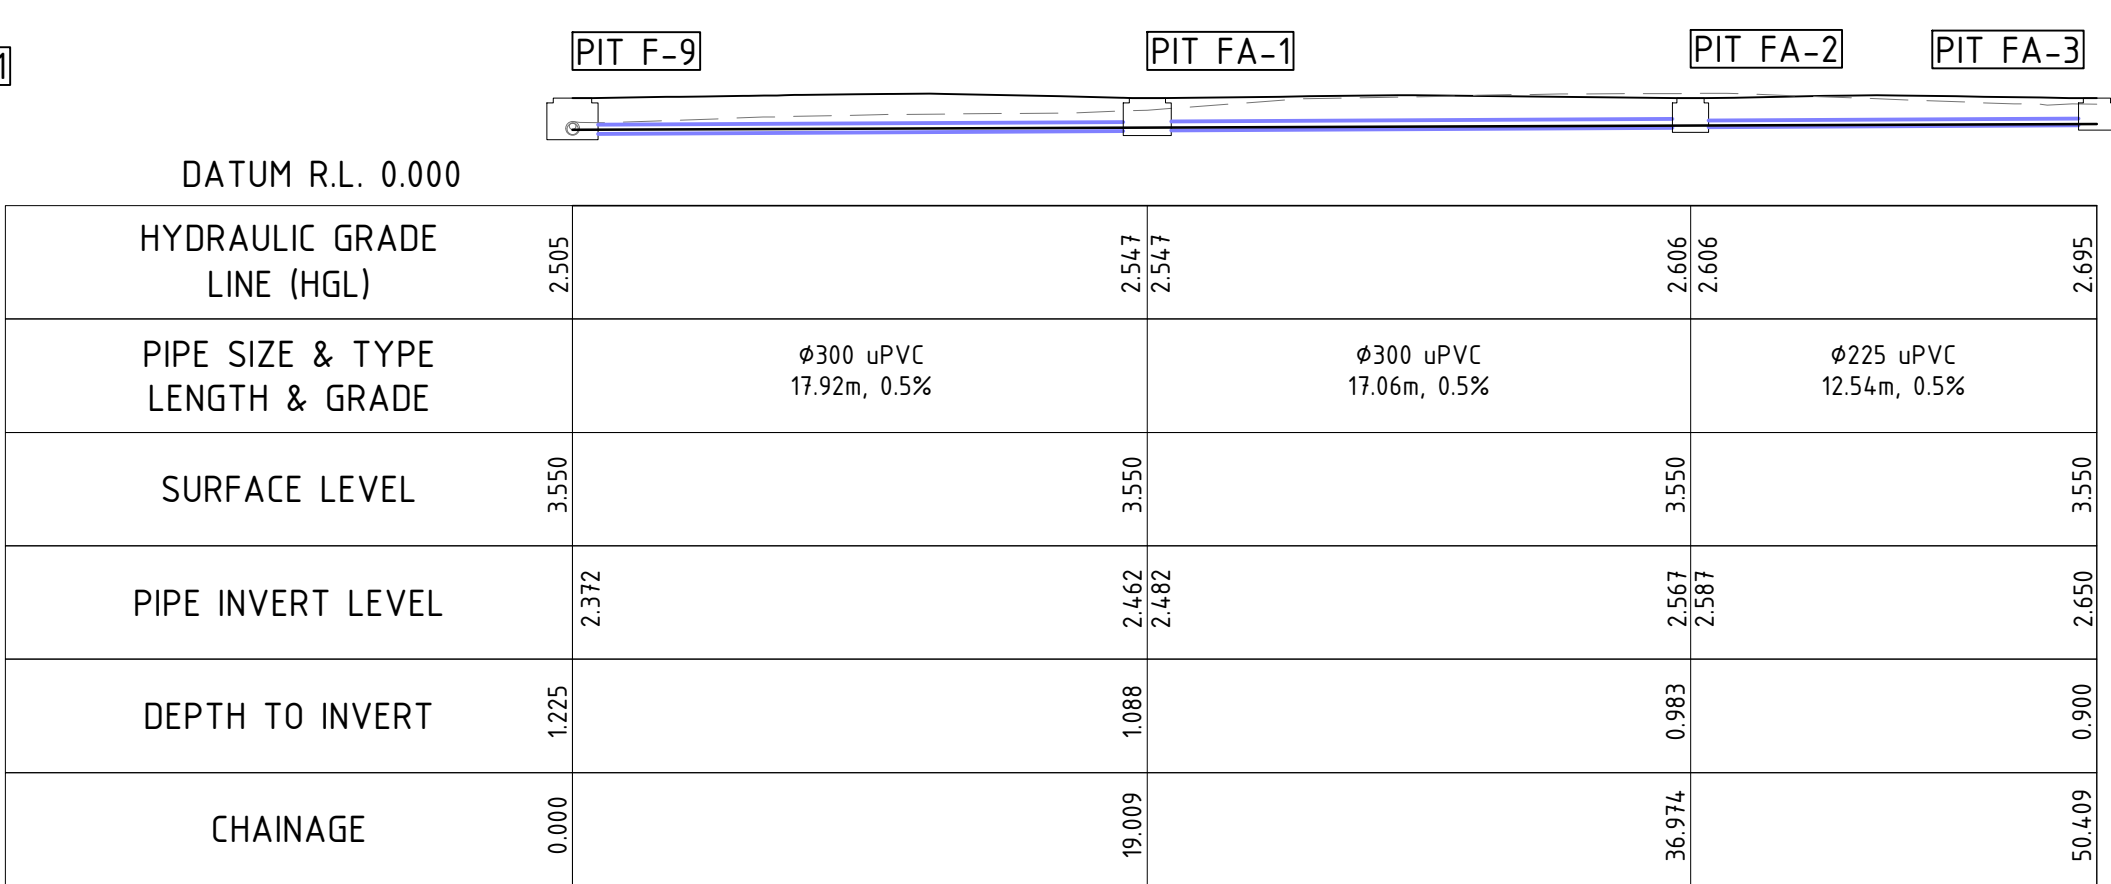
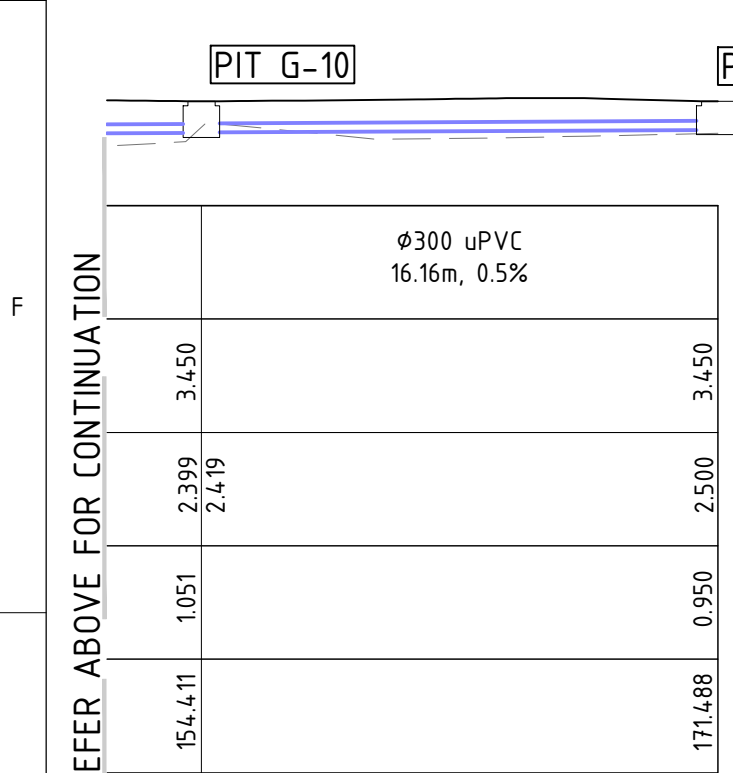
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SCALE 1:250




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SCALE 1:250

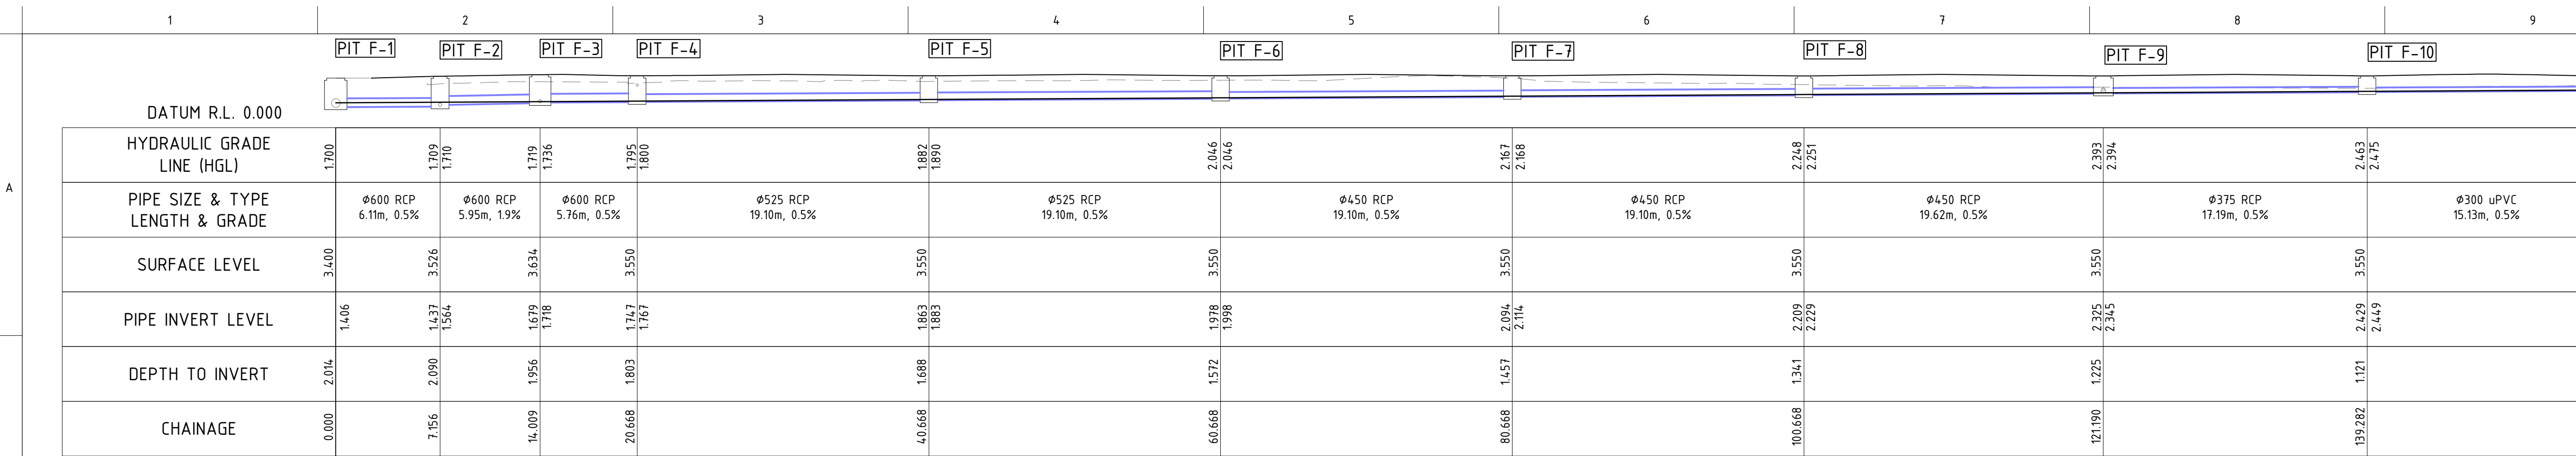

STORMWATER LONGTITUDINAL SECTION - LINE G
SCALE 1:250

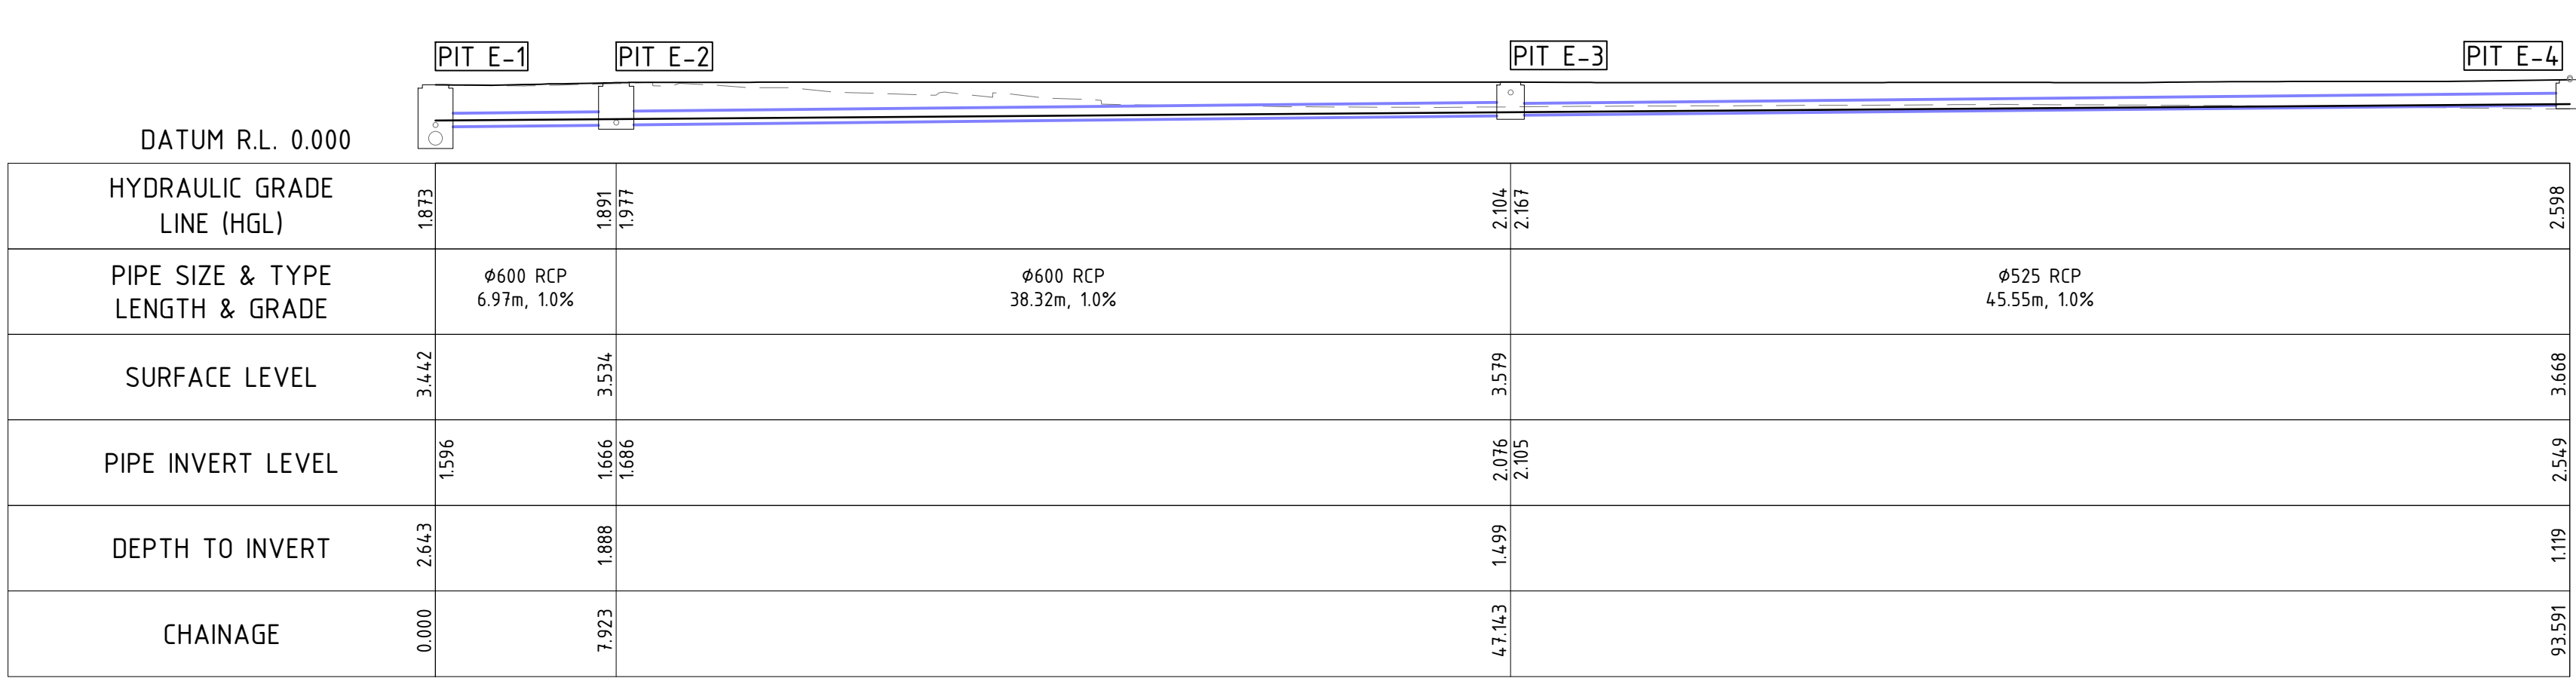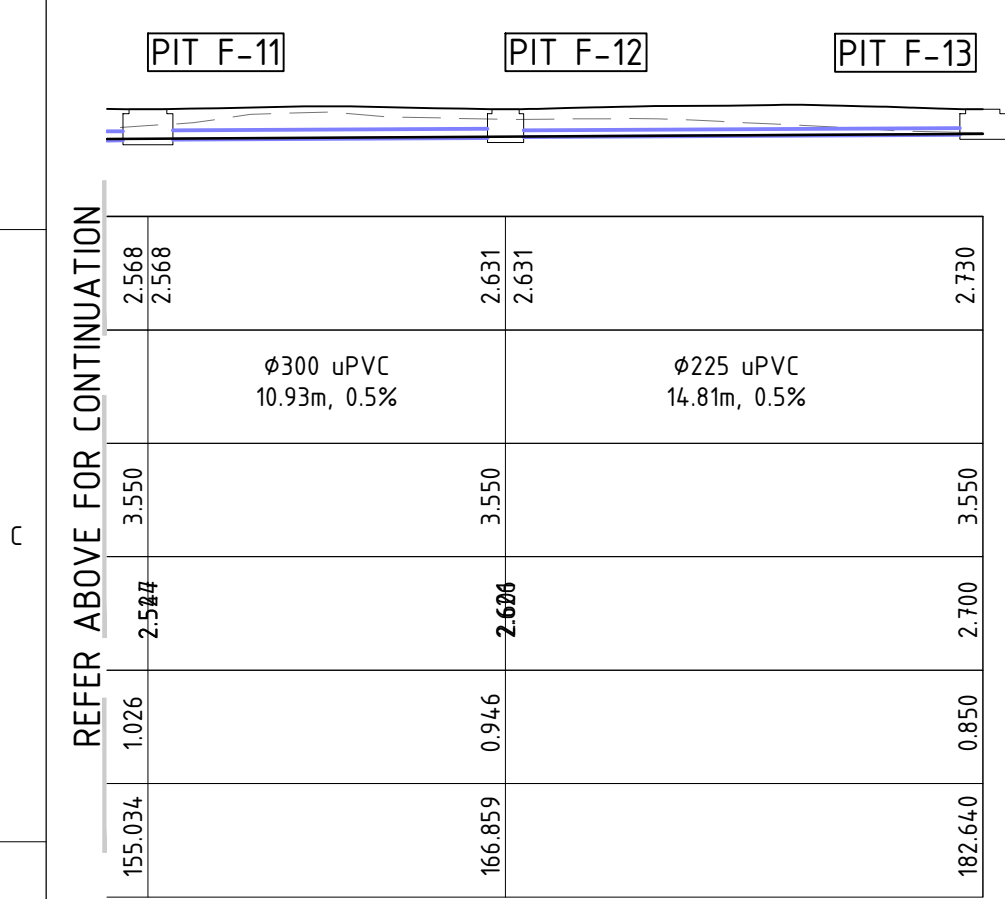

STORMWATER LONGTITUDINAL SECTION - LINE FA
SCALE 1:250

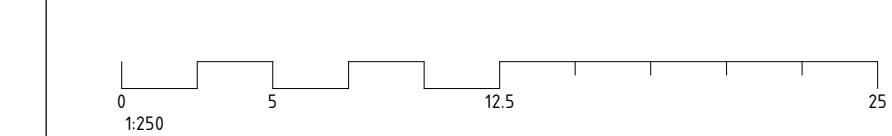

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REFERENCES

DATE	AMENDMENT	INIT	REV
12.08.24	DA ISSUE	MW	A
11.10.24	RESPONSE TO COUNCIL COMMENTS	MY	B
10.02.25	RESPONSE TO COUNCIL COMMENTS	MY	C

KEY PLAN

STRUCTURAL

-

MECHANICAL

-

ELECTRICAL

-

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DRAWING TITLE

MASTER PLAN
CONCEPT STORMWATER
LONGTITUDINAL SECTIONS - SHEET

DATE

JUNE 23

DESIGNED

JK

CHECKED

JK

APPROVED

MW

PROJECT No

23106

SCALE

1:250

SIZE

A1

REVISION

C

DRAWING No

DA4803

DEVELOPMENT APPLICATION ISSUE

